
BRUNSWICK COUNTY REST AREA RENOV. US 17 AT NC 130 CHALLOTTE NO

IC DEPT. OF II UILDING CODE SUMMA XCEPT 1 & 2-FAMILY DWEL EPRODUCE THE FOLLOWING DATA	RY FOR ALL COMME	RCIAL PROJECT		NC
ame Of Project: ddress: p Code: wner Or Authorized Agent:	BRUNSWICK COUNT 394 WHITEVILLE ROA 28470 W. S. Architects, PA	AD NW, SHALLOTTE Ph	, NC one: (919) 779-9797	
wned By: ode Enforcement Jurisdiction:	[] City/County [] Town	E-r [] Private [] County	nail ginger@wsarchi [X] Sta [X] Sta	ate
EAD DESIGN PROFESS	IONAL: W. S. ARCH		[1, 010	
esigner FIRM chitectural: W. S. Ard vil		LIC.# TELEI nmer 11075 (919)	PHONE 779-9797 ginger@w	E-MAIL sarchitectspa.com
ectrical: Burke Designer Alarm:		Burke 22038 (919)		ırke@nc.rr.com
umbing: Burke Designerhanical: Burke Designerhaler-Standpipe:	gn Group Benjamin E. E gn Group Benjamin E. E 	Burke 22038 (919) Burke 22038 (919)	771-1916 benbu 771-1916 benbu 	ırke@nc.rr.com ırke@nc.rr.com
ructural: Lysaght & taining Walls	Assoc. James E. Struf	ffolino 15887 	jes@lysa 	ghtassociates.com
>5' High: her:				
018 NC BUILDING CODI	E: [] New Building [X] Addition		[] 1st Time Interior	·
18 NC EXISTING BUILDING			evel I []	Historic Property Change of Use
	[] Repair [] Chapter 14			Change of Ose
CONSTRUCTED: (c	,	URRENT OCCUP	` , ` ,	
•	late) P EGORY (Table 1604.5): 0	ROPOSED OCCU	(): B
ASIC BUILDING DATA ONSTRUCTION TYPE:	[]I-A []II-A []III	l-A []IV []V-,	 A	
PRINKLERS:	[]I-B []II-B []III [X]NO [] PARTIAL	I-B [X]\	′-B	[] NFPA 13D
TANDPIPES: RIMARY FIRE DISTRICT:	[X] NO CLASS []I	[] [] OD HAZARD AREA:	[]WET []DI	
PECIAL INSPECTIONS EQUIRED:	[X]NO []YES			
ROSS BUILDING AREA				
BRD FLOOR 2ND FLOOR	EXISTING (SF)	NEW (SF) 	SUB-TOTAL 	TENANT
MEZZANINE 1ST FLOOR	600 2,435	 268	600 2,703	
BASEMENT TOTAL	3,036	268	3,303	
LOWABLE AREA:				
RIMARY OCCUPANCY:] ASSEMBLY	[]A-1 []A-2 []A-3 [] A-4 [] A-5		
X]BUSINESS]EDUCATIONAL]FACTORY	[] F-1 Moderate [1 F-2 Low		
] HIGH-HAZARD] INSTITUTIONAL	[] H-1 Detonate [] H- [] I-1 [] I-2 [] I-3 [2 Deflagrate []H-]I-4	3 Combust []H-4	Health []H-5 HPM
	I-2 Condition 1 1]2]2]2 []3 []4	[]5	
] MERCANTILE] RESIDENTIAL] STORAGE	[] R-1 [] R-2 [] R-3 [[] S-1 Moderate []R-4 1S-2 Low [1HI	GH-PILED	
JUTILITY & MISCELLANEOU	[] PARKING GARAGE [JOPEN []EN	ICLOSED [] REPAIR GARAGE
CCESSORY OCCUPANCY (NCIDENTAL USES (Table 50)	9):			
This separation is not open PECIAL USES (Chapter 4 - L PECIAL PROVISIONS (Chapter 4 - L	exempt as a Non-Separated list Code Sections): oter 5 - List Code Sections):		S).	
IIXED OCCUPANCY:	Separation: NON SEPAR	ATED MIXED USE F		cception:
Allowable Area	Occupancy A + a of Occupancy A	Actual Area of O Allowable Area o	f Occupancy B	≤1
	+		+	= ≤ 1.00
STORY DESCR	'N BLDG AREA TAB	(B) (C) LE 506.24 AREA F	OR ALLOWABL	E
NO. AND US	(ACTUAL)	REA OPEN SE INCREA	SE 1,5 UNLIMITED) 2,3
1 B 	3,303 9 	0,000 6,750 	-	
Frontage Area Increases Fro	om Section 506 2 Are Comp	eted Thus:		
A. Perimeter Which Front B. Total Building Perimeter	s A Public Way Or Open Sp er = 910' (P).	pace Having 20 Ft Mi	n. Width = 910' (F).	
C. Ratio (F/P) = 1 (F/P). D. W= Minimum Width Of Unlimited area applicable un	der conditions of Section 50)7.		
Max. Building Area = Total N The Maximum Area Of Open Control Towers Must Comply	lo. Of Stories In The Buildin Parking Garages Must Cor	g X D (maximum 3 st	ories) (506.2). ne Maximum Area Of	Air Traffic
Frontage increase is based of		alue in Table 506.2.		

1. Provide code reference if the "Shown on Plans" quantity is not based on Table 504.3 or 504.4.

	NTS	CODE	SUMMARY			00111	INUED
BUILDING ELEMENT	FIRE SEP'N DIST. (FT)	RATING REQ'D	RATING PROV'D (W/* REDUCTION)	DETAIL # AND SHEET #	DES. # FOR RATED ASS'Y	DES. # FOR RATED PENET'N	DES. # FOR RATEI JOINT
STRUCTURAL FRAME, INCLUDING COLUMNS GIRDERS, TRUSSES BEARING WALLS EXTERIOR	≥ 30'	0	0				
NORTH EAST WEST			 	 		 	
SOUTH INTERIOR NONBEARING WALLS AND PARTITIONS							
EXTERIOR NORTH EAST	≥ 30' ≥ 30'	0	0				
WEST SOUTH INTERIOR WALL & PARTITIONS FLOOR CONSTRUCTION INCLUDING SUPPORTING	≥ 30' ≥ 30'	0 0 0 	0 0 0 	 	 	 	
BEAMS AND JOISTS FLOOR CEILING ASSEMBLY COLUMNS SUPPORTING FLOORS ROOF CONSTRUCTION	3		 	 		 	
INCLUDING SUPPORTING BEAMS AND JOISTS ROOF CEILING ASSEMBLY		0	0				
COLUMNS SUPPORTING ROOF SHAFTS ENCLOSURES-EXIT SHAFTS ENCLOSURES-OTHER			 				
CORRIDOR SEPARATION OCCUPANCY/FIRE BARRIER							
SEPARATION PARTY/FIRE WALL SEPARATION SMOKE BARRIER SEPARATION							
SMOKE PARTITION TENANT/DWELLING UNIT/SLEEPING							
UNIT SEPARATION INCIDENTAL USE SEPARATION							
*INDICATE SECTION NO. PERMITTING							
PERCENTAGE OF WALL OPEN FIRE SEPARATION DISTANCE (FEET) FROM PROPERTY LINES	DEGE	ALCULAT REE OF NINGS ECTION E 705.8)	FIONS ALLOWAB AREA (%)	0	JAL SHOW N PLANS (%)	/N	
 	`						
EXIT SIGNS: [X] YE FIRE ALARM: [] YE:	S []NO S [X]N	10 17	NIC HARDWARE	=:	[] '-	S [X] NO	
		ATIONIS (C	PUADTED 7)	SHEET	NUMBER	A1.0	
[X] FIRE AND/OR SMOKE RATED WA [] ASSUMED AND REAL PROPERTY [] EXTERIOR WALL OPENING AREA [X] OCCUPANCY USE FOR EACH AF [X] OCCUPANT LOADS FOR EACH AF [X] EXIT ACCESS TRAVEL DISTANCE [] COMMON PATH OF TRAVEL DISTANCE [] DEAD END LENGTHS (1020.4) [X] CLEAR EXIT WIDTHS FOR EACH [X] MAXIMUM CALCULATED OCCUP EGRESS WIDTH (1005.3) [X] ACTUAL OCCUPANT LOAD FOR IT [] A SEPARATE SCHEMATIC PLAN IN STRUCTURE IS PROVIDED FOR IT [] LOCATION OF DOORS WITH PANIO [] LOCATION OF DOORS WITH DELA [] LOCATION OF DOORS WITH ELEC [] LOCATION OF DOORS EQUIPPED [] LOCATION OF EMERGENCY ESCA [] THE SQUARE FOOTAGE OF EACH [] THE SQUARE FOOTAGE OF EACH [] NOTE ANY CODE EXCEPTIONS OF THE ITEMS ABOVE	ALL LOCALINE LOCALINE LOCALINE LOCALINE REA AS IT REA ANT LOALINE REACH DOCALINE CHARDLY LOCALINE REACH DOCALINE REACH DOCALINE REACH DOCALINE REACH DOCALINE REACH DOCALINE REACH DOCALINE REACH REAC	CATIONS ESPECT T F RELATE 1006.2.1 & OOR AD CAPAC OOR WARE (10 RESS LOC GNETIC E DOWS (10 REA (202) COMPAR	(IF NOT ON SIT O DISTANCE TO S TO OCCUPAR (1006.3.2(1)) CITY EACH EXIT E FIRE RATED CCUPANCY SER 10.1.10) CKS AND THE A GRESS LOCKS N DEVICES 1030)	FE PLAN) O ASSUMED NT LOAD CAN FLOOR/CEII PARATION AMOUNT OF (1010.1.9.9)	PROPER LCULATION ACCOMM LING AND THE DEL	TY LINES (7 ON (TABLE 1 MODATE BA /OR ROOF AY (1010.1.9	SED ON
[] ASSUMED AND REAL PROPERTY [] EXTERIOR WALL OPENING AREA [X] OCCUPANCY USE FOR EACH AF [X] OCCUPANT LOADS FOR EACH AF [X] EXIT ACCESS TRAVEL DISTANCI [] COMMON PATH OF TRAVEL DISTA [] DEAD END LENGTHS (1020.4) [X] CLEAR EXIT WIDTHS FOR EACH [X] MAXIMUM CALCULATED OCCUPEGRESS WIDTH (1005.3) [X] ACTUAL OCCUPANT LOAD FOR ITALITY OF LOAD FOR ITALITY OF LOAD FOR ITALITY OF LOATION OF DOORS WITH PANION OF LOCATION OF DOORS WITH DELATION OF DOORS WITH DELATION OF DOORS WITH ELECTION OF LOCATION OF LOCATION OF LOCATION OF LOCATION OF EMERGENCY ESCAPION OF LOCATION OF EMERGENCY ESCAPION OF EMERGENCY ESCAPION OF LOCATION OF LO	ALL LOCALINE LOCALINE LOCALINE LOCALINE LOCALINE REA AS IT REA AS IT ANCES (1 EXIT DO ANT LOALINE PURPOS CHARDLY LYED EGITROMACHINE WITH HOLD FIRE AF SMOKEN TABLE	CATIONS ESPECT T T RELATE) 1006.2.1 & DOR AD CAPAC DOR WHER ES OF OC WARE (10 GNETIC E DOWS (10 REA (202) COMPAF NOTES T	(IF NOT ON SIT O DISTANCE TO S TO OCCUPAN A 1006.3.2(1)) CITY EACH EXIT E FIRE RATED CCUPANCY SER 10.1.10) CKS AND THE A GRESS LOCKS N DEVICES 1300) RTMENT FOR OF THAT MAY HAVE	E PLAN) O ASSUMED NT LOAD CAN FLOOR/CEIL PARATION AMOUNT OF (1010.1.9.9) CCUPANCY E BEEN UTIL	O PROPER LCULATION N ACCOMM LING AND THE DEL	TY LINES (7 DN (TABLE 1 MODATE BA /OR ROOF AY (1010.1.9 CATION I-2 GARDING	SED ON 9.7) (407.5)
[X] FIRE AND/OR SMOKE RATED WA [] ASSUMED AND REAL PROPERTY [] EXTERIOR WALL OPENING AREA [X] OCCUPANCY USE FOR EACH AF [X] OCCUPANT LOADS FOR EACH AF [X] EXIT ACCESS TRAVEL DISTANCE [] COMMON PATH OF TRAVEL DISTANCE [] DEAD END LENGTHS (1020.4) [X] CLEAR EXIT WIDTHS FOR EACH [X] MAXIMUM CALCULATED OCCUPATE [X] MAXIMUM CALCULATED OCCUPATE [X] ACTUAL OCCUPANT LOAD FOR IT [X] A SEPARATE SCHEMATIC PLAN IN STRUCTURE IS PROVIDED FOR IT [X] LOCATION OF DOORS WITH PANIO [X] LOCATION OF DOORS WITH DELA [X] LOCATION OF DOORS WITH ELEC [X] LOCATION OF DOORS WITH ELEC [X] THE SQUARE FOOTAGE OF EACH [X] THE SQUARE FOOTAGE OF EACH [X] THE ITEMS ABOVE	ALL LOCALINE LOCALINE LOCALINE LOCALINE LOCALINE REA AS IT REA CHOCANT LOADICATINE PURPOS CHARDY LYED EGITROMAC WITH HOLD FIRE AF SMOKE N TABLE (SECOLUMN (CATIONS ESPECT T T RELATE) 1006.2.1 & DOR AD CAPAC DOR WHER ES OF OC WARE (10 RESS LOC GNETIC E DOWS (10 REA (202) COMPAF NOTES T	(IF NOT ON SIT O DISTANCE TO S TO OCCUPAN A 1006.3.2(1)) CITY EACH EXIT E FIRE RATED CCUPANCY SER 10.1.10) CKS AND THE A GRESS LOCKS N DEVICES 030) RTMENT FOR OF THAT MAY HAVE	FE PLAN) O ASSUMED NT LOAD CAN FLOOR/CEII PARATION AMOUNT OF (1010.1.9.9)	PROPER LCULATION ACCOMM LING AND THE DEL	MODATE BA MODATE BA MOR ROOF AY (1010.1.9 CATION I-2 GARDING B S AC	SED ON (407.5)
[X] FIRE AND/OR SMOKE RATED WA [] ASSUMED AND REAL PROPERTY [] EXTERIOR WALL OPENING AREA [X] OCCUPANCY USE FOR EACH AF [X] OCCUPANT LOADS FOR EACH AF [X] EXIT ACCESS TRAVEL DISTANCI [] COMMON PATH OF TRAVEL DISTANCI [] DEAD END LENGTHS (1020.4) [X] CLEAR EXIT WIDTHS FOR EACH [X] MAXIMUM CALCULATED OCCUP EGRESS WIDTH (1005.3) [X] ACTUAL OCCUPANT LOAD FOR I [] A SEPARATE SCHEMATIC PLAN IN STRUCTURE IS PROVIDED FOR I [] LOCATION OF DOORS WITH PANIO [] LOCATION OF DOORS WITH DELA [] LOCATION OF DOORS WITH ELEC [] LOCATION OF EMERGENCY ESCA [] THE SQUARE FOOTAGE OF EACH [] THE SQUARE FOOTAGE OF EACH [] NOTE ANY CODE EXCEPTIONS OF THE ITEMS ABOVE ACCESSIBLE DWELLING UNITS ACCESSIBLE ACCESSIE TOTAL UNITS UNITS UNITS PROV'D	ALL LOCALINE LOCALINE LOCALINE LOCALINE LOCALINE REA AS IT REA ES (1017 ANCES	CATIONS ESPECT T T RELATE) 1006.2.1 & DOR AD CAPAC DOR WHER ES OF OC WARE (10 RESS LOC GNETIC E DOWS (10 REA (202) COMPAF NOTES T TYPE A UNITS REQ'D	(IF NOT ON SIT O DISTANCE TO S TO OCCUPAN A 1006.3.2(1)) CITY EACH EXIT E FIRE RATED CCUPANCY SER 10.1.10) CKS AND THE A GRESS LOCKS N DEVICES 130) RTMENT FOR OF THAT MAY HAVE TYPE A UNITS PROV'D EXISTING TO	TE PLAN) O ASSUMED NT LOAD CAN FLOOR/CEIP PARATION AMOUNT OF (1010.1.9.9) CCUPANCY E BEEN UTIL TYPE B UNITS REQ'D REMAIN	O PROPER LCULATION ACCOMM LING AND A THE DEL. CLASSIFICATION TYPE UNITS PROV	MODATE BA MODATE	SED ON (407.5)
[X] FIRE AND/OR SMOKE RATED WA [] ASSUMED AND REAL PROPERTY [] EXTERIOR WALL OPENING AREA [X] OCCUPANCY USE FOR EACH AF [X] OCCUPANT LOADS FOR EACH AF [X] EXIT ACCESS TRAVEL DISTANCI [] COMMON PATH OF TRAVEL DISTANCI [] DEAD END LENGTHS (1020.4) [X] CLEAR EXIT WIDTHS FOR EACH [X] MAXIMUM CALCULATED OCCUPE EGRESS WIDTH (1005.3) [X] ACTUAL OCCUPANT LOAD FOR I [] A SEPARATE SCHEMATIC PLAN IN STRUCTURE IS PROVIDED FOR I [] LOCATION OF DOORS WITH PANICI [] LOCATION OF DOORS WITH DELA [] LOCATION OF DOORS WITH ELEC [] LOCATION OF DOORS WITH ELEC [] LOCATION OF EMERGENCY ESCA [] THE SQUARE FOOTAGE OF EACH [] THE SQUARE FOOTAGE OF EACH [] THE SQUARE FOOTAGE OF EACH [] NOTE ANY CODE EXCEPTIONS OF THE ITEMS ABOVE ACCESSIBLE DWELLING UNITS ACCESSIBLE ACCESSIE TOTAL UNITS UNITS UNITS PROV'D ACCESSIBLE PARKING (SECTION TOTAL OF SP. LOT OR PARKING AREA REQ'D PROV TOTAL # OF SP. LOT OR PARKING AREA REQ'D PROV	ALL LOCALINE LOCALINE LOCALINE LOCALINE LOCALINE REA AS IT REA ES (1017 ANCES	CATIONS ESPECT T T RELATE) 1006.2.1 & DOR AD CAPAC DOR WARE (10 RESS OF OC WARE (10 RESS LOC GNETIC E DOWS (10 REA (202) COMPAF NOTES T CTION 110 TYPE A UNITS REQ'D # C	(IF NOT ON SIT O DISTANCE TO S TO OCCUPAN A 1006.3.2(1)) CITY EACH EXIT E FIRE RATED CCUPANCY SEF 10.1.10) CKS AND THE A GRESS LOCKS N DEVICES 030) RTMENT FOR OC THAT MAY HAVE	TE PLAN) O ASSUMED NT LOAD CAN FLOOR/CEIP PARATION AMOUNT OF (1010.1.9.9) CCUPANCY E BEEN UTIL TYPE B UNITS REQ'D REMAIN E SPACES P VAN SPA	O PROPER LCULATION ACCOMM ING AND THE DEL CLASSIFICATION TYPE UNITS PROVIDED CES WITH	MODATE BA MODATE	SED ON 9.7) TOTAL CESSIBTS PRO OTAL # CESSIBL
[X] FIRE AND/OR SMOKE RATED WA [] ASSUMED AND REAL PROPERTY [] EXTERIOR WALL OPENING AREA [X] OCCUPANCY USE FOR EACH AF [X] OCCUPANT LOADS FOR EACH AF [X] EXIT ACCESS TRAVEL DISTANCE [] COMMON PATH OF TRAVEL DISTANCE [] DEAD END LENGTHS (1020.4) [X] CLEAR EXIT WIDTHS FOR EACH [X] MAXIMUM CALCULATED OCCUPEGRESS WIDTH (1005.3) [X] ACTUAL OCCUPANT LOAD FOR ITEL [] A SEPARATE SCHEMATIC PLAN IN STRUCTURE IS PROVIDED FOR ITEL [] LOCATION OF DOORS WITH PANICATION OF DOORS WITH PANICATION OF DOORS WITH DELA [] LOCATION OF DOORS WITH ELEC [] LOCATION OF EMERGENCY ESCAN ITEL [] THE SQUARE FOOTAGE OF EACH [] NOTE ANY CODE EXCEPTIONS OF THE ITEMS ABOVE ACCESSIBLE DWELLING UNITS ACCESSIBLE DWELLING UNITS ACCESSIBLE PARKING (SECTION IN TERMS ABOVE ACCESSIBLE PARKING (SECTION IN TERMS ABOVE) ACCESSIBLE PARKING (SECTION IN TERMS ABOVE)	ALL LOCALINE LOCALINE LOCALINE LOCALINE LOCALINE REA AS IT REA ES (1017 ANCES	CATIONS ESPECT T T RELATE) 1006.2.1 & DOR AD CAPAC DOR WARE (10 RESS OF OC WARE (10 RESS LOC GNETIC E DOWS (10 REA (202) COMPAF NOTES T CTION 110 TYPE A UNITS REQ'D # C	(IF NOT ON SIT O DISTANCE TO S TO OCCUPAN A 1006.3.2(1)) CITY EACH EXIT E FIRE RATED CCUPANCY SER 10.1.10) CKS AND THE A GRESS LOCKS N DEVICES 030) RTMENT FOR OCHAT MAY HAVE TYPE A UNITS PROV'D EXISTING TO DE ACCESSIBLE G. WITH 5' 125SS AISLE	TYPE B UNITS REQ'D REMAIN E SPACES P VAN SPA 32" ACCES TE ASSUMED TO A SECURATION TO BE SECURATED TO A SE	O PROPER LCULATION ACCOMM ING AND THE DEL CLASSIFI LIZED RECOMM TYPE UNIT: PROV ROVIDED CES WITH S 8' ACCI	MODATE BA MODATE	SED ON OTAL CESSIBI OTAL # CESSIBI
[X] FIRE AND/OR SMOKE RATED WA [] ASSUMED AND REAL PROPERTY [] EXTERIOR WALL OPENING AREA [X] OCCUPANCY USE FOR EACH AF [X] OCCUPANT LOADS FOR EACH AF [X] OCCUPANT LOADS FOR EACH AF [X] EXIT ACCESS TRAVEL DISTANCI [] COMMON PATH OF TRAVEL DISTANCI [] DEAD END LENGTHS (1020.4) [X] CLEAR EXIT WIDTHS FOR EACH [X] MAXIMUM CALCULATED OCCUP EGRESS WIDTH (1005.3) [X] ACTUAL OCCUPANT LOAD FOR I [] A SEPARATE SCHEMATIC PLAN IN STRUCTURE IS PROVIDED FOR I [] LOCATION OF DOORS WITH PANIC [] LOCATION OF DOORS WITH DELA [] LOCATION OF DOORS WITH ELEC [] LOCATION OF DOORS WITH ELEC [] LOCATION OF EMERGENCY ESCA [] THE SQUARE FOOTAGE OF EACH [] THE SQUARE FOOTAGE OF EACH [] NOTE ANY CODE EXCEPTIONS OF THE ITEMS ABOVE ACCESSIBLE DWELLING UNITS ACCESSIBLE ACCESSIE TOTAL UNITS UNITS UNITS UNITS UNITS TOTAL UNITS UNITS UNITS ACCESSIBLE ACCESSIE TOTAL UNITS UNITS TOTAL UNITS UNITS TOTAL UNITS UNITS ACCESSIBLE PARKING (SECTION ACCESSIBLE PARKING (SECTION TOTAL PROVIDE ACCESSIBLE PARKING REQ'D PROVE	ALL LOCALINE LOCALINE LOCALINE LOCALINE LOCALINE REA AS IT REA ES (1017 ANCES	CATIONS ESPECT T T RELATE) 1006.2.1 8 DOR AD CAPAC DOR WHERES OF OR WARE (10 RESS LOR GNETIC EDUD-OPER DOWS (10 REA (202) COMPAF NOTES T TION 110 TYPE A UNITS REQ'D # C REC ACC	(IF NOT ON SIT O DISTANCE TO S TO OCCUPAN A 1006.3.2(1)) CITY EACH EXIT E FIRE RATED CCUPANCY SER 10.1.10) CKS AND THE A GRESS LOCKS N DEVICES 130) RTMENT FOR OF THAT MAY HAVE TYPE A UNITS PROV'D EXISTING TO OF ACCESSIBLE G. WITH 5' 12ESS AISLE 403.1)	TYPE B UNITS REQ'D REMAIN E SPACES P VAN SPA 32" ACCES AISLE	TYPE UNIT: PROVIDED ICES WITH S 8' ACCI AISL	MODATE BA MODATE	SED ON OTAL CESSIBTS PRO OTAL # CESSIBL OVIDED
[X] FIRE AND/OR SMOKE RATED WA [] ASSUMED AND REAL PROPERTY [] EXTERIOR WALL OPENING AREA [X] OCCUPANCY USE FOR EACH AF [X] OCCUPANT LOADS FOR EACH AF [X] EXIT ACCESS TRAVEL DISTANCE [] COMMON PATH OF TRAVEL DISTANCE [] DEAD END LENGTHS (1020.4) [X] CLEAR EXIT WIDTHS FOR EACH [X] MAXIMUM CALCULATED OCCUPANT LOAD FOR IDEAD END LENGTHS (1020.4) [X] ACTUAL OCCUPANT LOAD FOR IDEAD END ID	ALL LOCALINE LOCALINE LOCALINE LOCALINE LOCALINE REA AS IT REA ES (1017 ANCES	CATIONS ESPECT T T RELATE) 1006.2.1 & DOR AD CAPAC OR RES OF OC WARE (10 RES LOC GNETIC E DLO-OPEI DOWS (10 REA (202) COMPAF NOTES T TION 110 TYPE A UNITS REQ'D # C REC ACC (TABLE SPC, SEPA	(IF NOT ON SIT O DISTANCE TO S TO OCCUPAN A 1006.3.2(1)) CITY EACH EXIT E FIRE RATED CCUPANCY SER 10.1.10) CKS AND THE A GRESS LOCKS N DEVICES 130) RTMENT FOR OF THAT MAY HAVE TYPE A UNITS PROV'D EXISTING TO OF ACCESSIBLE G. WITH 5' 12ESS AISLE 403.1)	TYPE B UNITS REQ'D REMAIN E SPACES P VAN SPA 32" ACCES AISLE IES ARE NO	TYPE UNIT: PROV	MODATE BA MODATE	OTAL # CESSIBL OVIDED ESS TH.

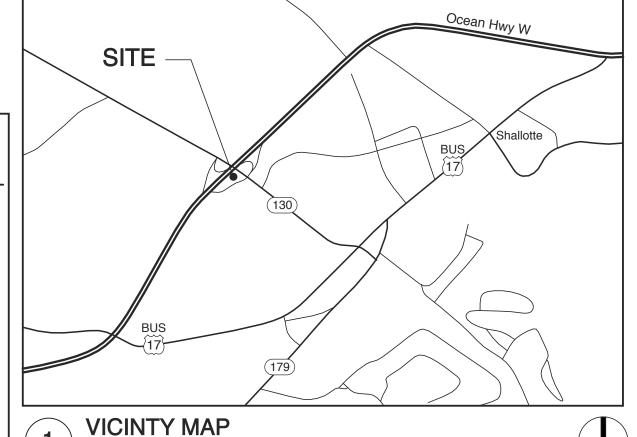

VICINTY MAP SCALE: NTS

NC DEPT. OF INSURANCE 2018 APPENDIX B BUILDING CODE SUMMARY

90.1 (2013) Standard

Shallotte, North Carolina

COM*check* Software Version COMcheckWeb

Designer/Contractor:

CONTINUED

Envelope Compliance Certificate

Project Information

Energy Code: Project Title: Climate Zone: Project Type:

Construction Site:

New Construction Vertical Glazing / Wall Area:

EnergyPlus 8.1.0.009 (EPW: USA_NC_Wilmington.Intl.AP.723013_TMY3.epw) Performance Sim. Specs:

Brunswick

Floor Area **Building Area**

Owner/Agent:

Envelope Assemblies

1-Retail : Nonresidential

Assembly	Gross Area or Perimeter	Cavity R-Value	Cont. R-Value	Proposed U-Factor	Budget U- Factor _(a)
Roof: Attic Roof, Wood Joists, [Bldg. Use 1 - Retail]	260	42.0	0.0	0.024	0.027
NORTH					
Ext. Wall: Wood-Framed, 24in. o.c., [Bldg. Use 1 - Retail]	849	19.0	5.0	0.047	0.089
Window: Other Window: Fixed, Perf. Specs.: Product ID trifab, SHGC 0.25, PF 0.10, VT 0.55, [Bldg. Use 1 - Retail] (c)	246			0.550	0.350
Door: Glass (over 50% glazing): Metal Frame, Entrance Door, Perf. Specs.: Product ID storefront, SHGC 0.25, VT 0.55, [Bldg. Use 1 - Retail] (c)	42			0.770	0.770
<u>EAST</u>					
Ext. Wall: Wood-Framed, 24in. o.c., [Bldg. Use 1 - Retail]	849	19.0	5.0	0.047	0.089
Window: Other Window: Fixed, Perf. Specs.: Product ID trifab, SHGC 0.25, PF 0.43, VT 0.55, [Bldg. Use 1 - Retail] (c)	51			0.550	0.350
Window: Other Window: Fixed, Perf. Specs.: Product ID trifab, SHGC 0.25, PF 0.10, VT 0.55, [Bldg. Use 1 - Retail] (c)	288			0.550	0.350
<u>SOUTH</u>					
Ext. Wall: Wood-Framed, 24in. o.c., [Bldg. Use 1 - Retail]	849	19.0	5.0	0.047	0.089
Window: Other Window: Fixed, Perf. Specs.: Product ID trifab, SHGC 0.25, PF 0.10, VT 0.55, [Bldg. Use 1 - Retail] (c)	164			0.550	0.350

- (a) Budget U-factors are used for software baseline calculations ONLY, and are not code requirements. (b) 'Other' components require supporting documentation for proposed U-factors.
- (c) Fenestration product performance must be certified in accordance with NFRC and requires supporting documentation. velope PASSES: Design 1% better than code

Envelope Compliance Statement

Compliance Statement: The proposed envelope design represented in this document is consistent with the building plans, specifications, and other calculations submitted with this permit application. The proposed envelope systems have been designed to meet the 90.1 (2013) Standard requirements in COMcheck Version COMcheckWeb and to comply with any applicable mandatory requirements listed in the Inspection Checklist.

Name - Title		Signature	Date
STRUCTURAL I	DESIGN	(COPIED FROM STRUCTUAL NOTE SHE	EET)
CODE:	NORTH CAROLINA STATE	BUILDING CODE - 2018 EDITION (IBC	2015)

BUILDING RISK CATEGORY (NCSBC 2018 TABLE 1604.5) DESIGN LOADS: ROOF LIVE LOAD FLOOR LIVE LOAD (Main Floor)
FLOOR LIVE LOAD (Upper Level Office)

FLOOR LIVE LOAD (Upper Level Office)	50 PS
SNOW LOAD DATA :	
GROUND SNOW LOAD	10 PS
SNOW EXPOSURE FACTOR	1.0
SNOW LOAD IMPORTANCE FACTOR	1.0
THERMAL FACTOR	1.1
FLAT ROOF SNOW LOAD	12.7 PS
ROOF SLOPE FACTOR	1.0
PITCHED ROOF SNOW LOAD	7.7 PS
WIND LOAD DATA :	
ULTIMATE DESIGN WIND SPEED, Vult	147 MF
NOMINAL DESIGN WIND SPEED, Vasd	114 MF
WIND EXPOSURE	"B" w/ Oper
INTERNAL PRESSURE COEFFICIENTS (Addition)	+0.18,

- en Patches WIND BASE SHEAR (Addition, x-x Direction) WIND BASE SHEAR (Addition, y-y Direction)
 INTERNAL PRESSURE COEFFICIENTS (Covered Entry 11.3 KIPS +0.0, -0.0 WIND BASE SHEAR (Covered Entry, x-x Direction WIND BASE SHEAR (Covered Entry, y-y Direction WIND PRESSURE FOR COMPONENTS / CLADDING 2.4 KIPS 2.1 KIPS PER ASCE 7-10
- SEISMIC IMPORTANCE FACTOR MAPPED SPECTRAL RESPONSE ACCELERATION 0.293 0.115 MAPPED SPECTRAL RESPONSE ACCELERATION SPECTRAL RESPONSE COEFFICIENT
 SPECTRAL RESPONSE COEFFICIENT
 SEISMIC DESIGN CATEGORY
 BASIC STRUCTURAL SYSTEM (Addition) Bearing Wall System SEISMIC RESISTING SYSTEM RESPONSE MODIFICATION COEFFICIENT SYSTEM OVERSTRENGTH FACTOR DEFLECTION AMPLIFICATION FACTOR SEISMIC RESPONSE COEFFICIENT ANALYSIS PROCEDURE


DEFLECTION AMPLIFICATION FACTOR

SEISMIC BASE SHEAR (Covered Entry)

ANALYSIS PROCEDURE

Light Framed Walls w/ Shear Panels Equivalent Lateral Force SEISMIC BASE SHEAR (Addition) BASIC STRUCTURAL SYSTEM (Covered Entry) Cantilevered Column System SEISMIC RESISTING SYSTEM Steel Ordinary Cantilevered Column RESPONSE MODIFICATION COEFFICIENT SYSTEM OVERSTRENGTH FACTOR

Equivalent Lateral Force

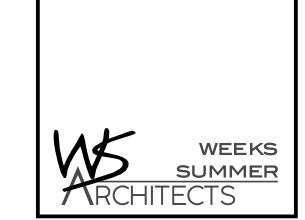

W. S. ARCHITECTS, PA 3305-109 Durham Drive Raleigh, North Carolina 27603 919.779.9797 www.wsarchitectspa.com





SCOPE OF WORK:

-ADDITION OF FAMILY RESTROOM -NEW RESTROOM ENTRANCE CANOPY -NEW INTERIOR FINISHES

DRAWING INDEX

A0.1 COVER SHEET SITE / LIFE SAFETY PLAN DEMO PLAN / DEMO ELEVATIONS

REV. FLOOR PLAN A1.2 A1.3 FINISH PLAN

ENLARGED PLAN & INT. ELEVATIONS RCP & ROOF PLAN, INT. ELEVATIONS

A2 REVISED ELEVATIONS A3.0 **BUILDING SECTIONS** A3.1 WALL SECTIONS

A3.2 WALL SECTIONS SCHEDULES A5 DETAILS

STRUCTURAL NOTES S1 FOUNDATION PLAN

S2 ROOF FRAMING PLAN & 2ND FLR S2A WALL ELEV. & LINTEL SCHEDULE S3 FOUNDATION & FRAMING DETAILS FRAMING DETAILS

FRAMING DETAILS S5 S6 FRAMING DETAILS

PLUMBING SPECIFICATIONS P2 DWV PLAN P3 WATER PLAN

HVAC SCHEDULES, NOTES M2 EXISTING HVAC PLAN М3 NEW HVAC PLAN **HVAC DETAILS**

ELECTRICAL DETAILS/SPECS E2 EXISTING ELEC. PLAN

NEW ELEC PLAN

ELECT. PANEL S RISERS

E3

E4

BRUNSWICK CTY. **REST AREA-RENOV.** US 17 AT NC 130 SHALLOTTE, NORTH CAROLINA

SCO ID# 21-24079-01A

5.1.23

15RE.13.3

PROJECT NO. 2104a DRAWING TITLE

BID SET

PROJECT TITLE


COVER SHEET

OF SHEET

PLOT DATE 6/16/23 00/00/21 REVISION


This original sheet is 22" x 34"; other dimensions indicate it has been altered.

All information on this sheet is the property of W. S. Architects, PA and may not be duplicated in whole or in part without written authorization from W. S. Architects, PA. 2020 ©

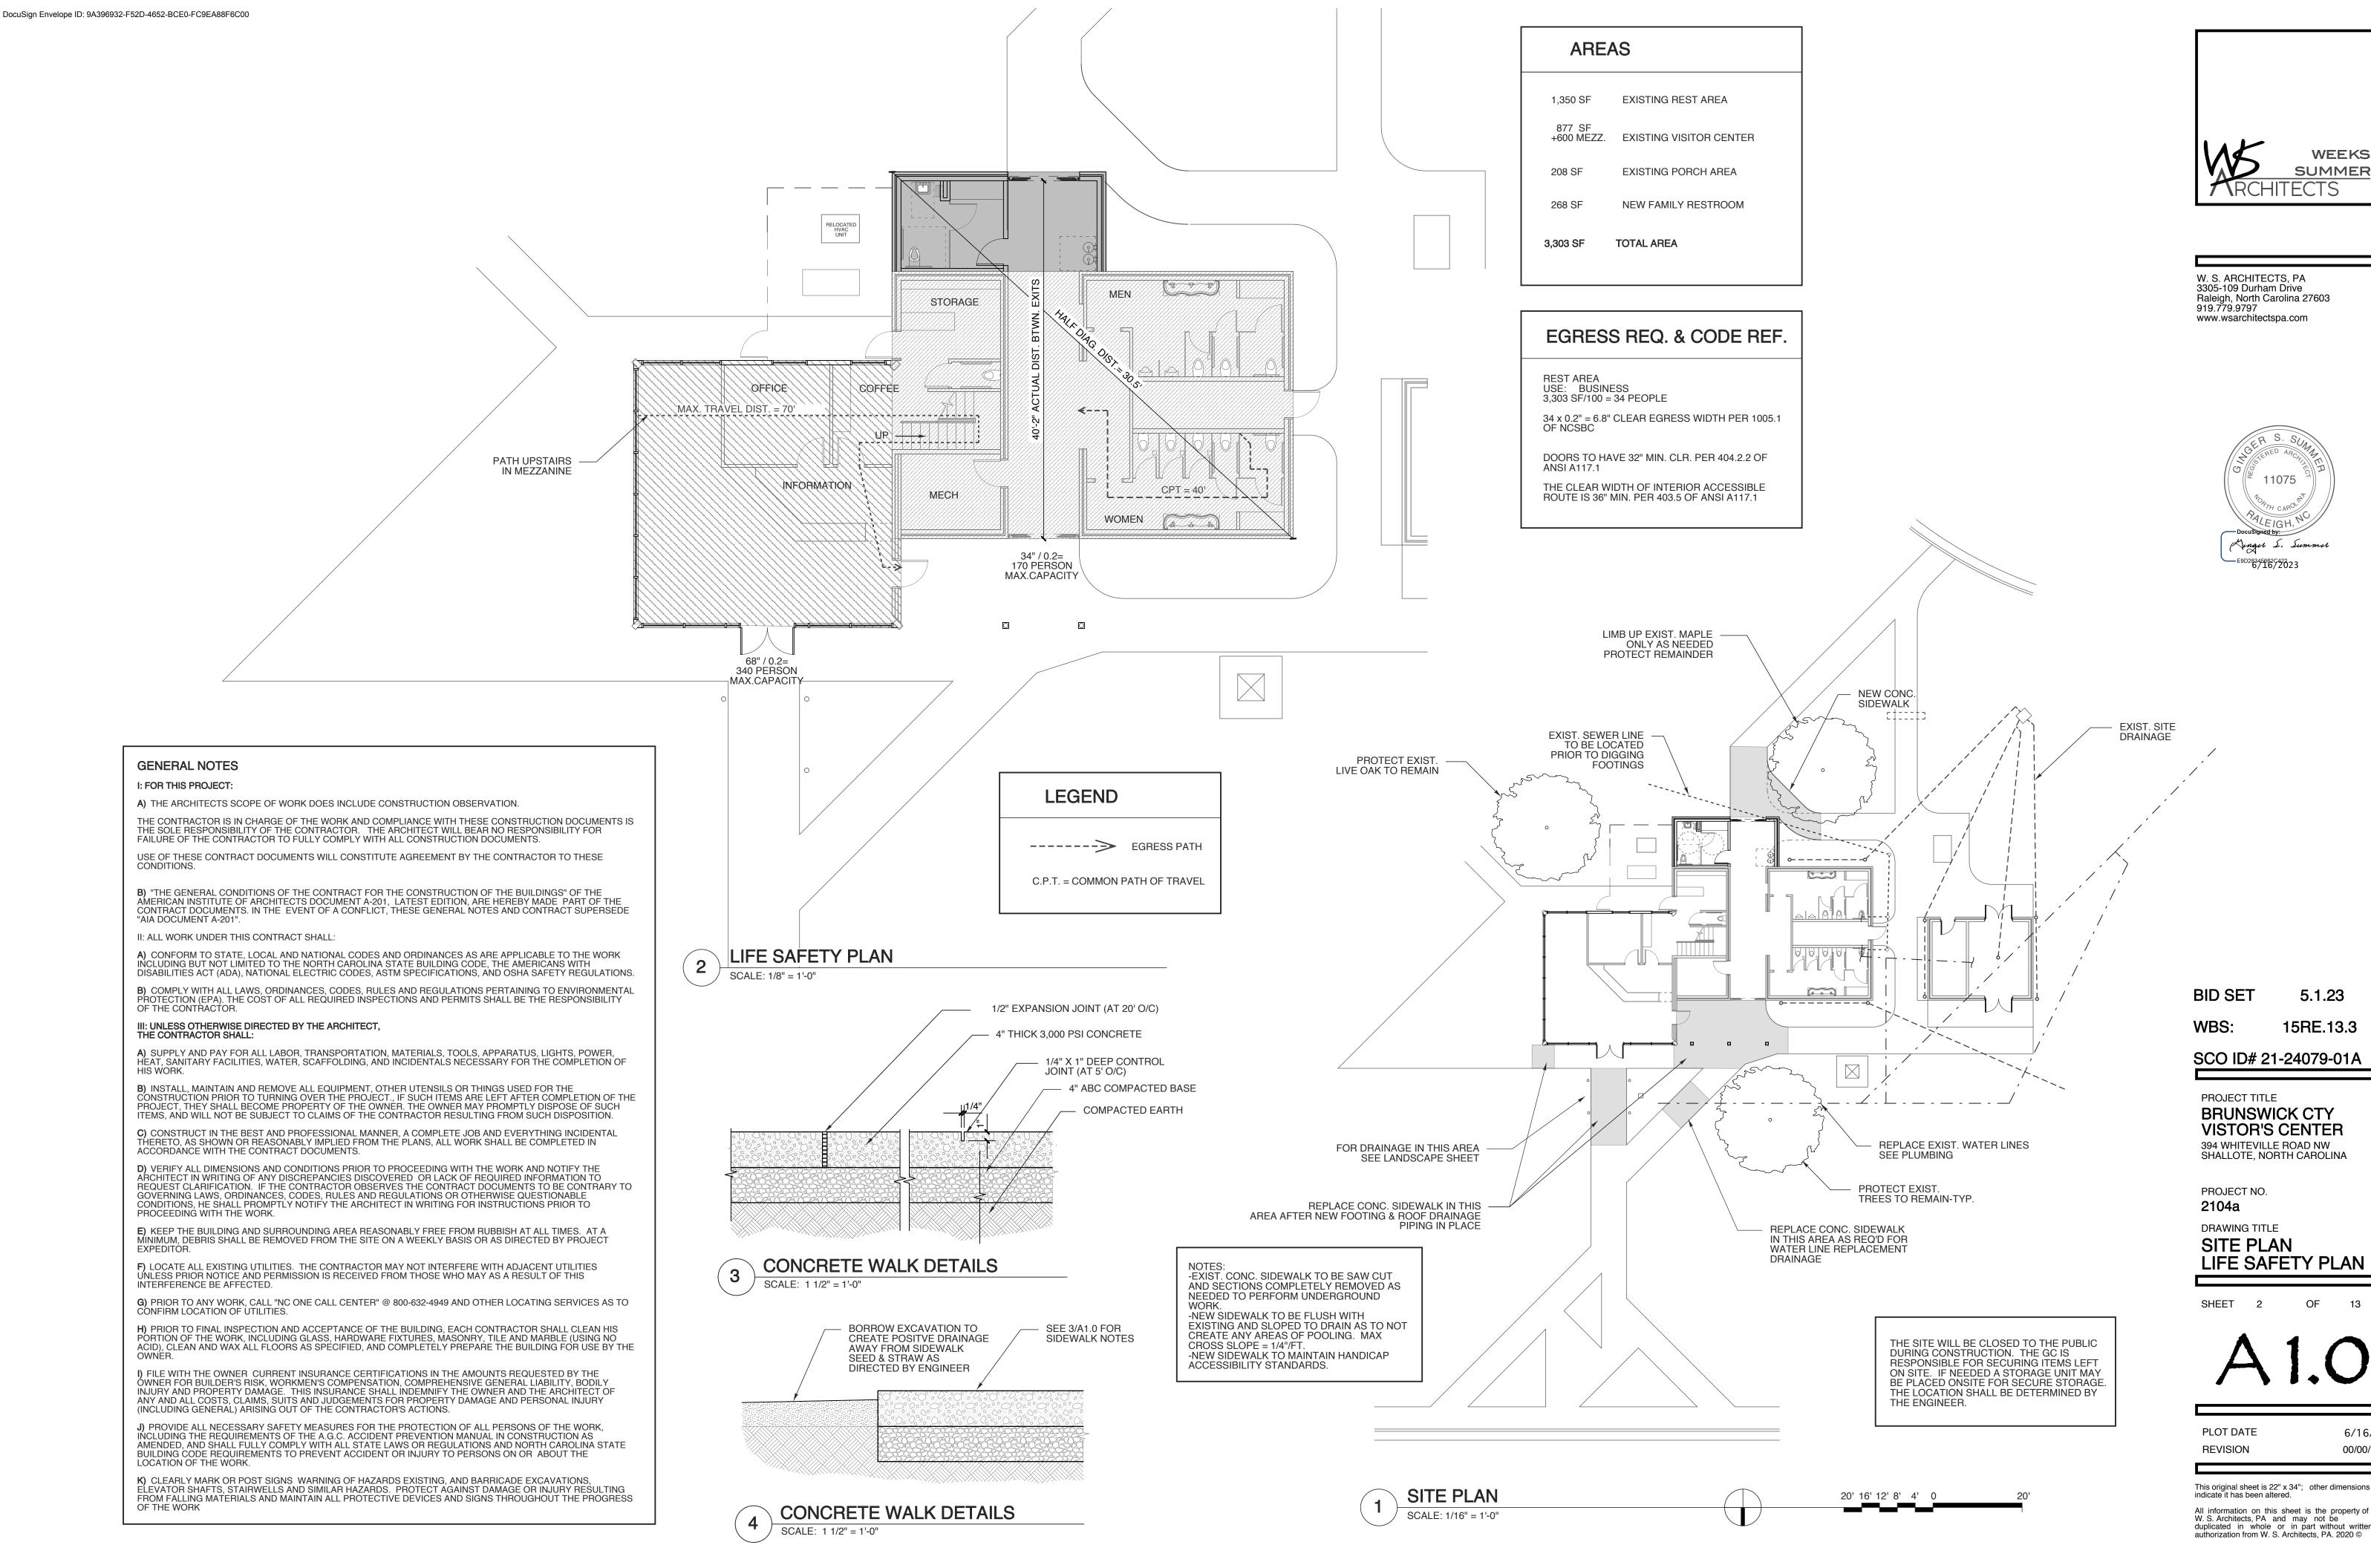

6/16/23

00/00/14

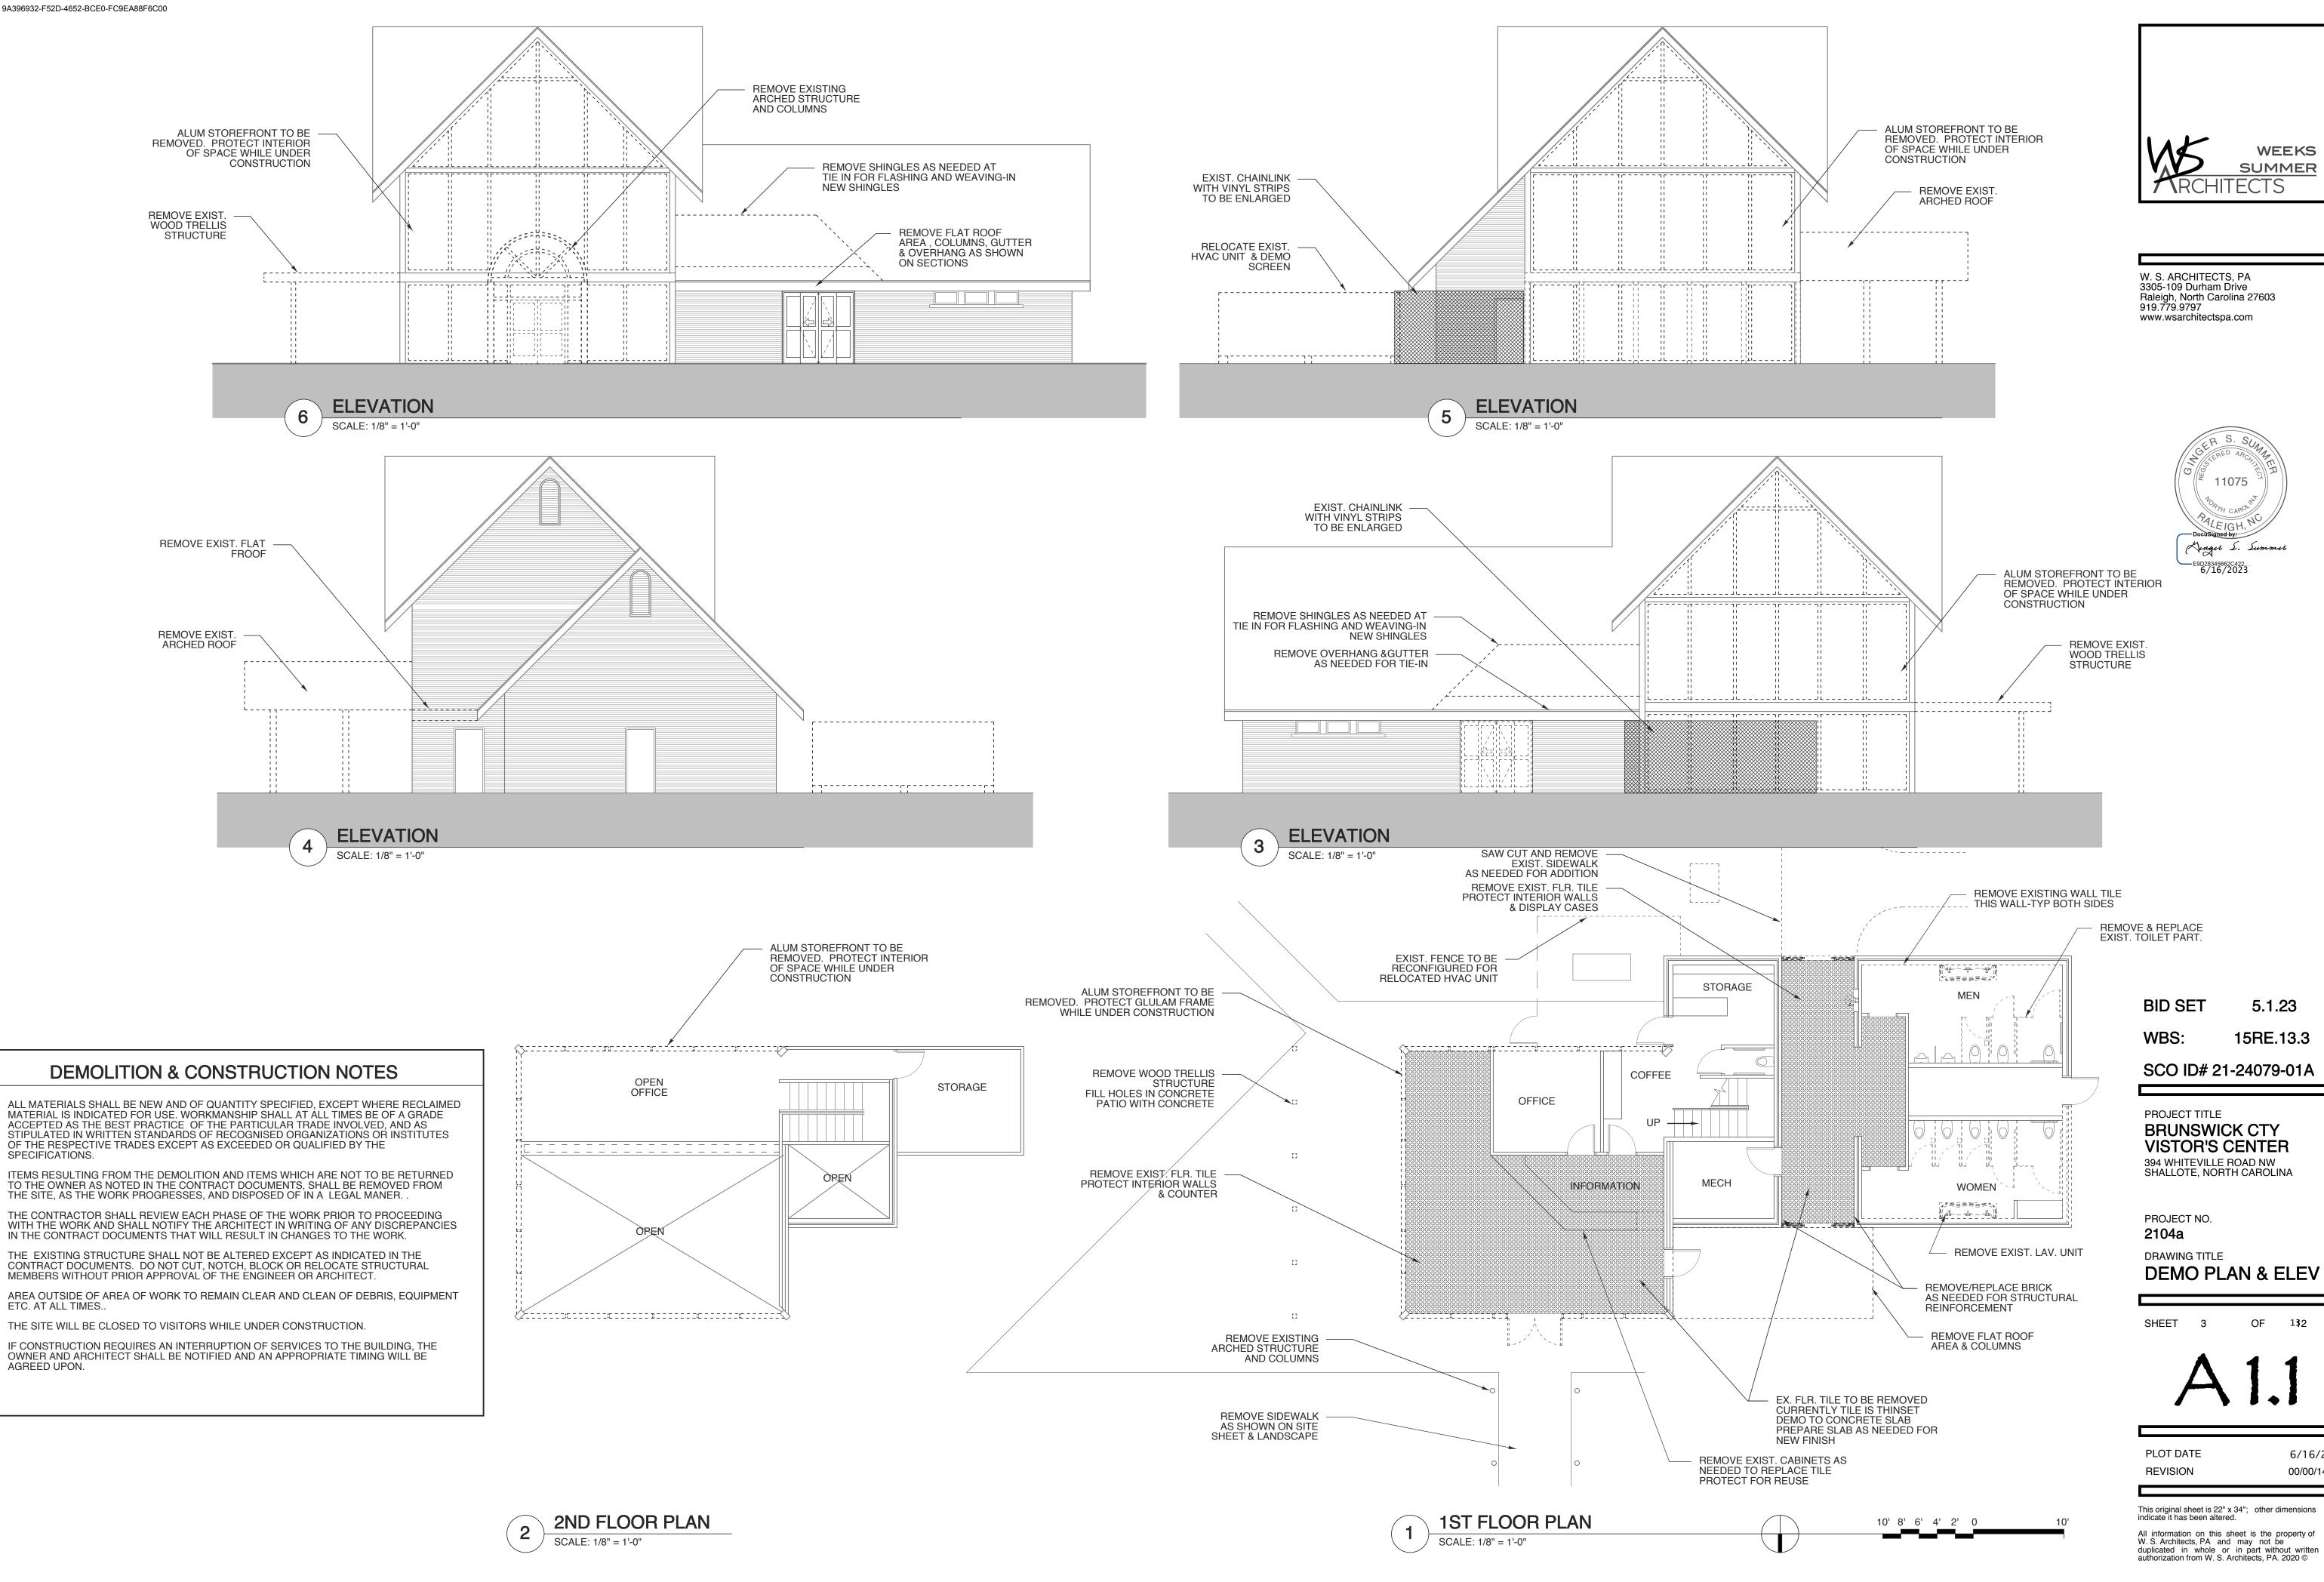

WEEKS


SUMMER


5.1.23

15RE.13.3

6/16/23

00/00/14

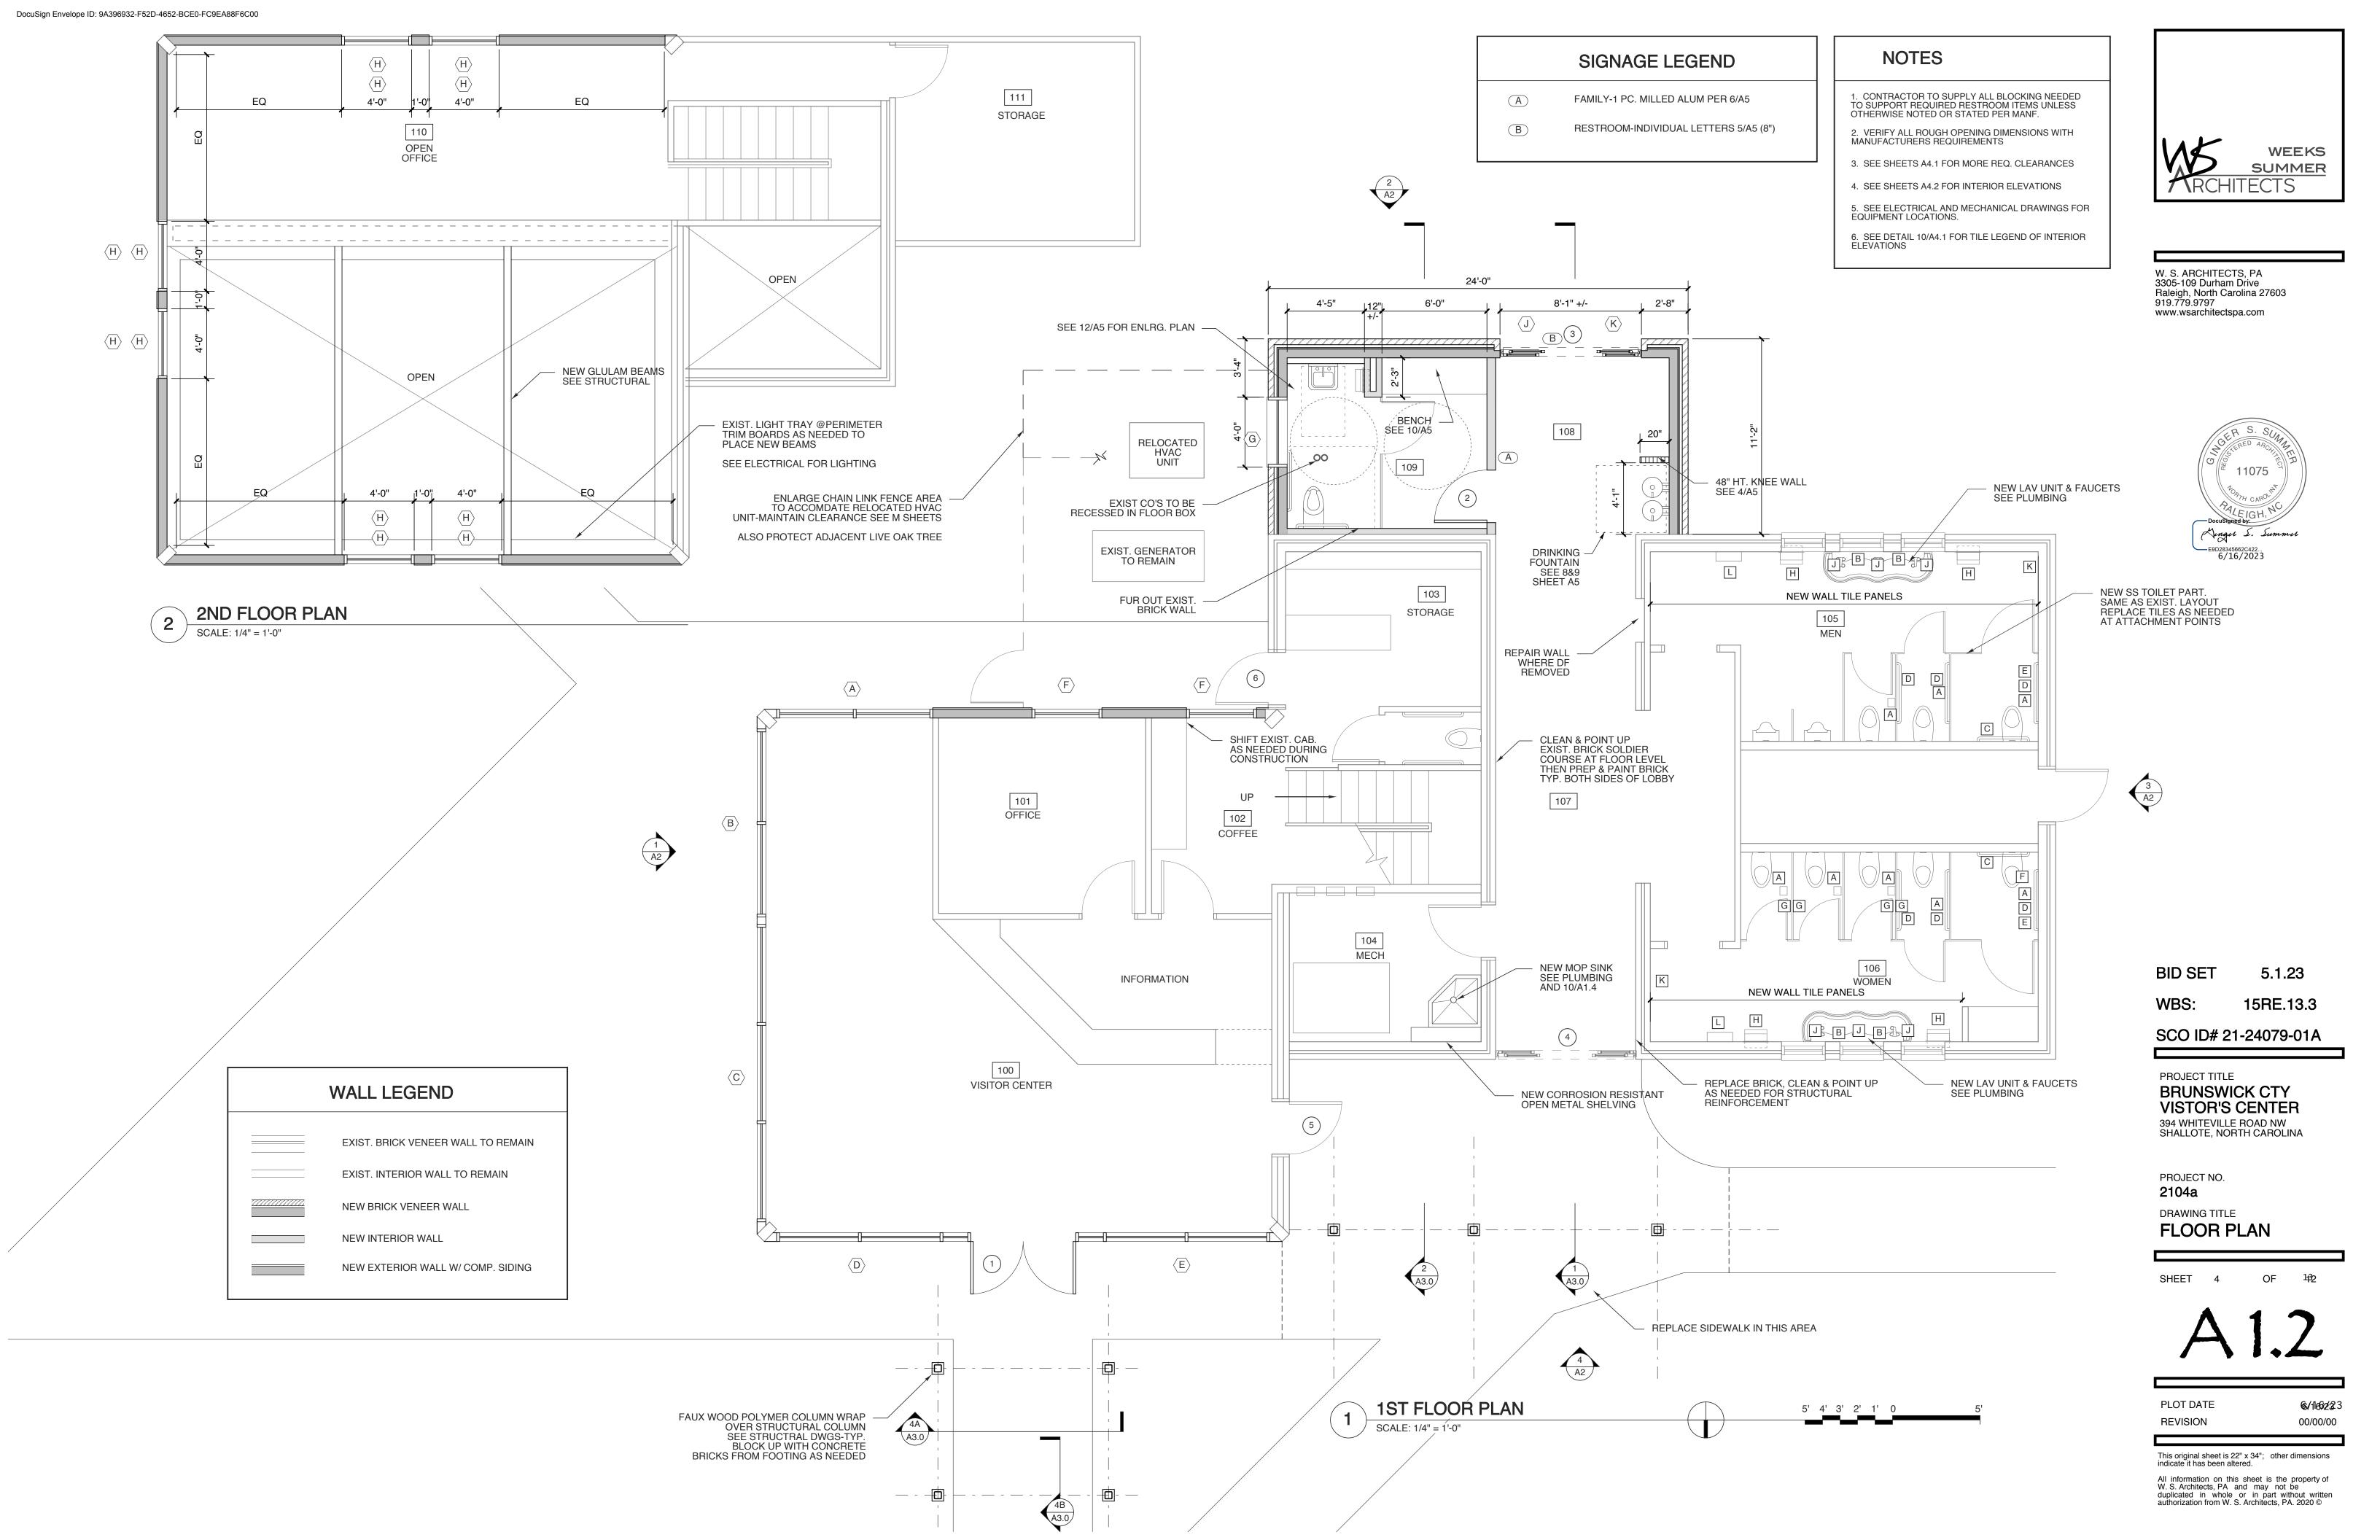

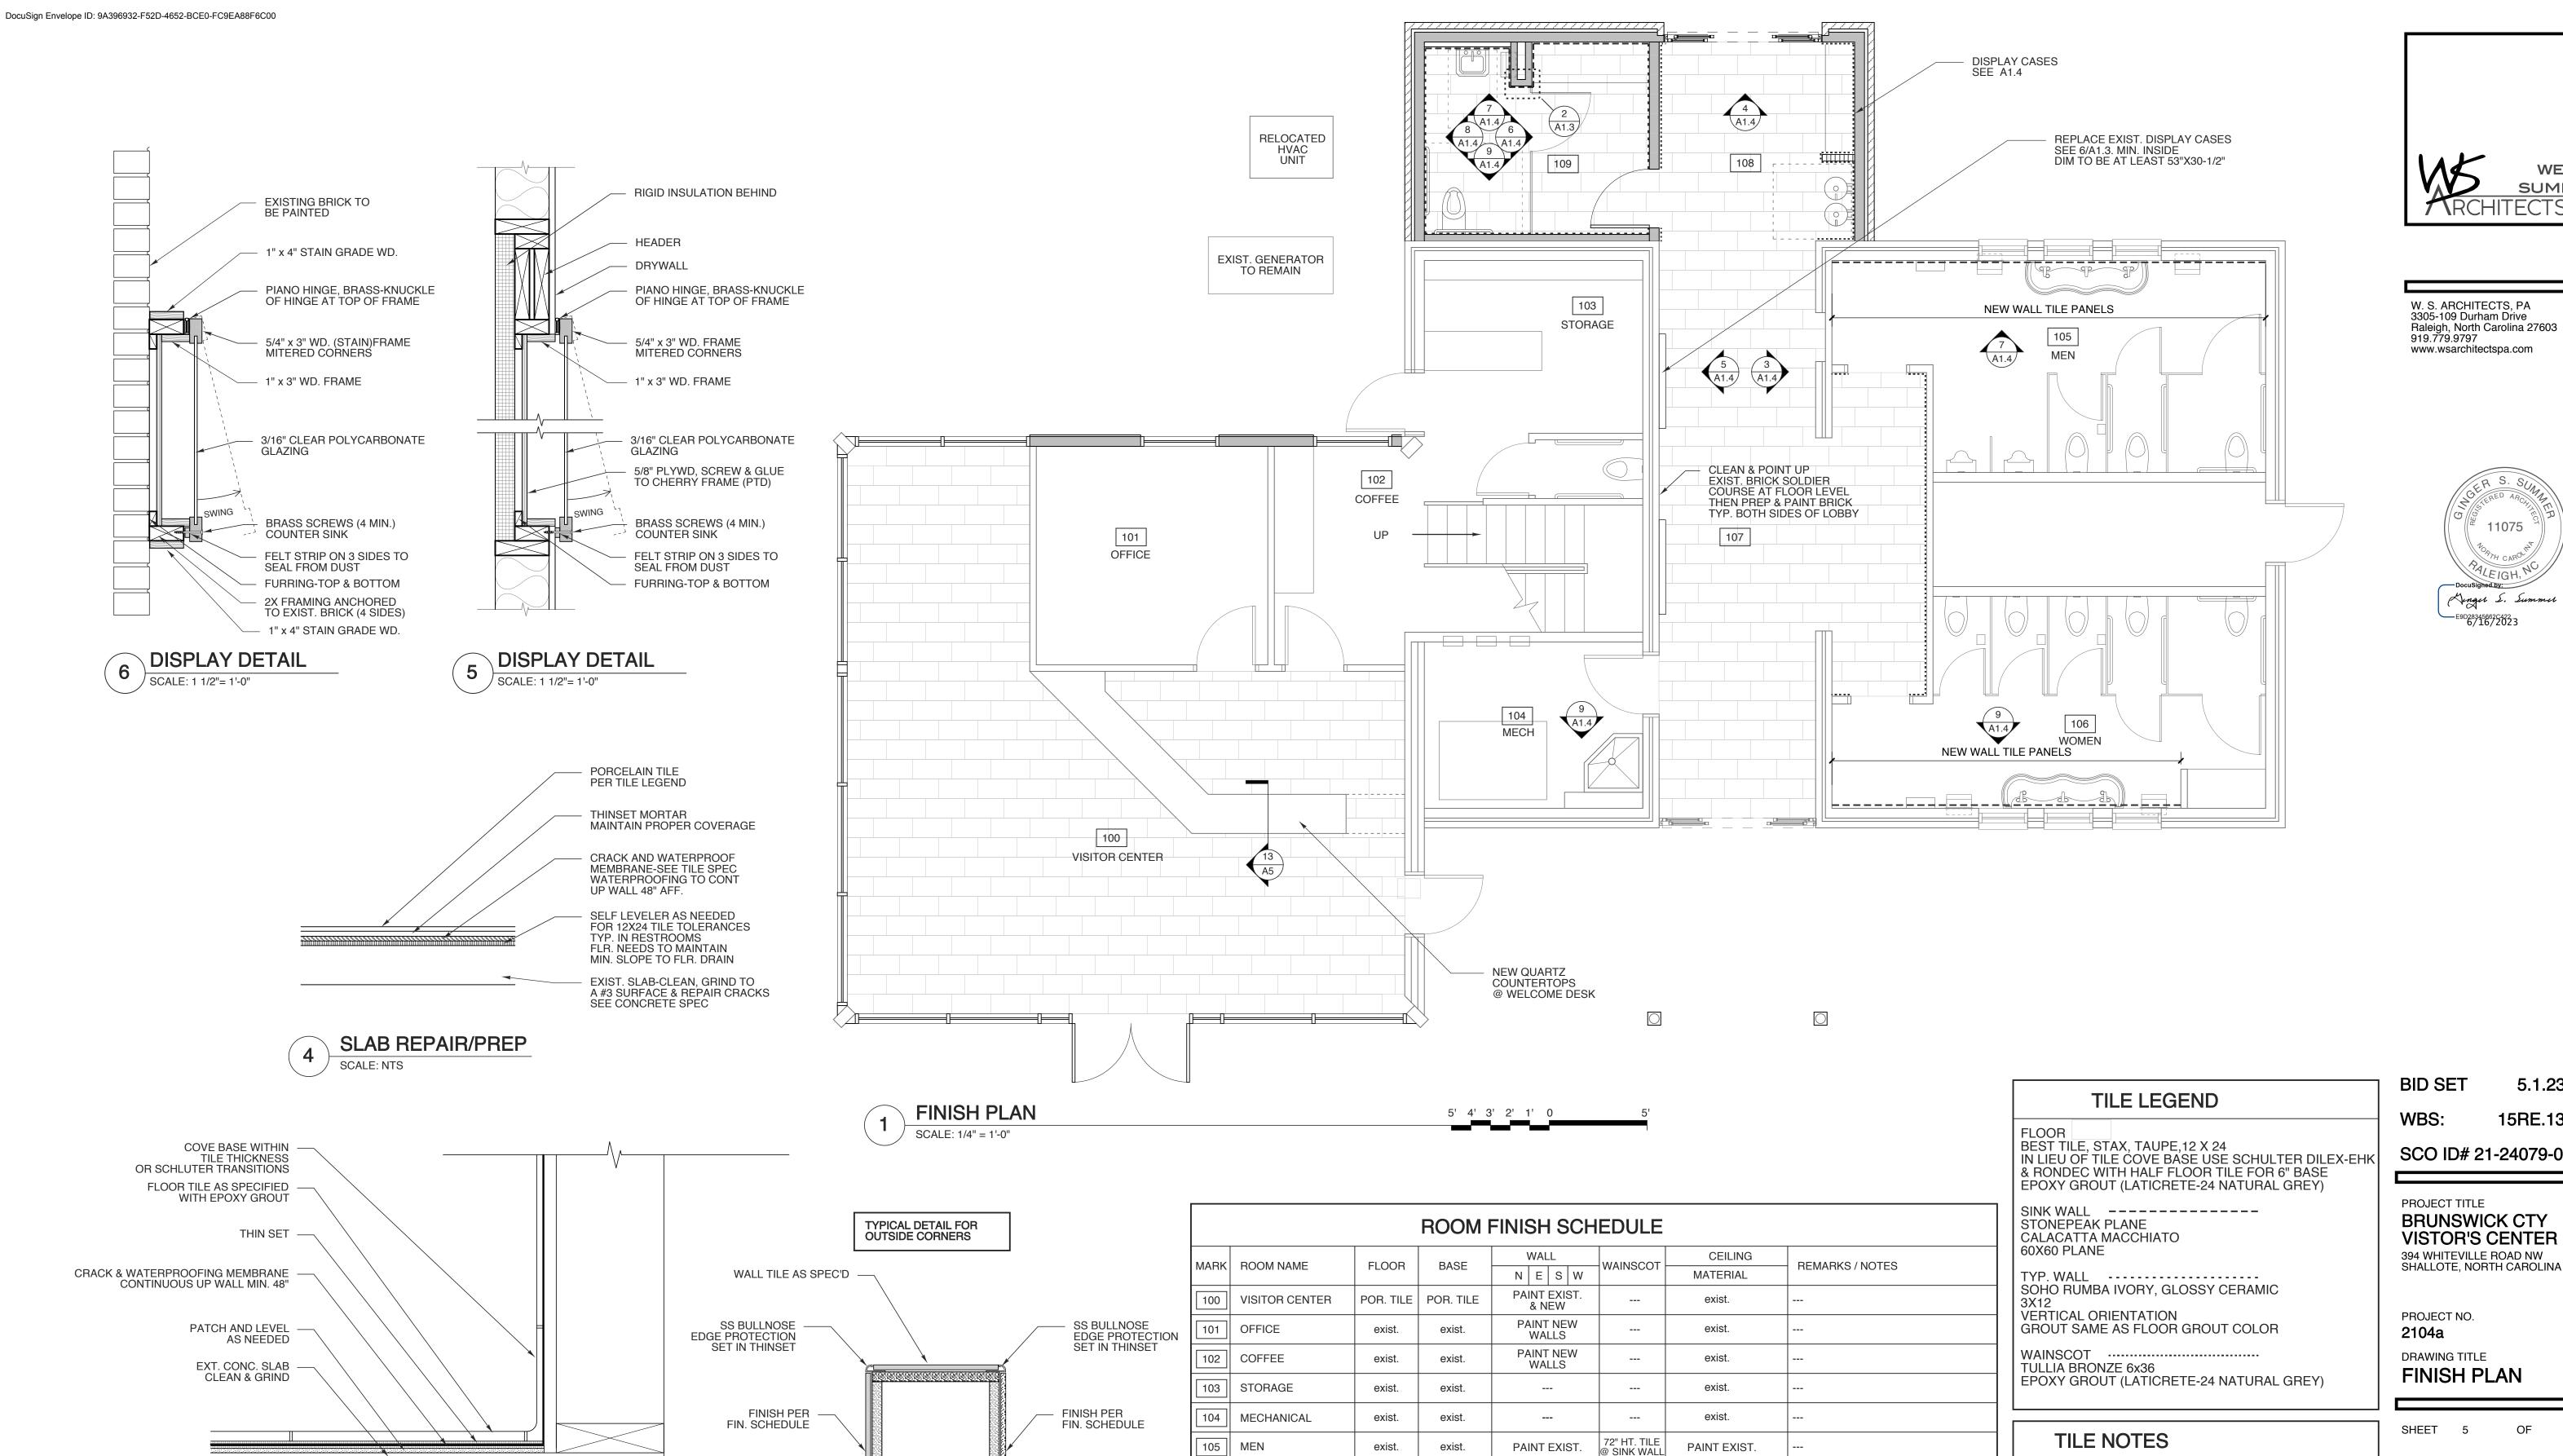

106 WOMEN

107 EXIST. LOBBY

108 NEW LOBBY

109 FAMILY ROOM

110 OPEN OFFICE

UPSTAIRS STORAGE

OUTSIDE CORNER/END WALL

SCALE: NTS

FLOOR TILE DETAIL

exist.

POR. TILE

POR. TILE

POR. TILE

exist.

exist.

exist.

POR. TILE

POR. TILE

POR. TILE

exist.

exist.

PAINT EXIST.

CLEAN & PAINT

EXIST. INCL. BRICK

PAINT NEW

WALL TILE

PAINT NEW

@ SINK WALL

POR TILE

PAINT EXIST.

PATCH AS NEEDED

PTD. DRYWALL

PTD. DRYWALL

exist.

exist.

PAINT AT ENTRY TO RESTROOMS

SCHULTER RONDEC TRIM AT TOP

OF WAINSCOT

WEEKS SUMMER

W. S. ARCHITECTS, PA 3305-109 Durham Drive Raleigh, North Carolina 27603 919.779.9797 www.wsarchitectspa.com



5.1.23

15RE.13.3

SCO ID# 21-24079-01A

PROJECT TITLE **BRUNSWICK CTY** VISTOR'S CENTER 394 WHITEVILLE ROAD NW

DRAWING TITLE

OF

6/16/23

00/00/00

PLOT DATE REVISION

WALL TILE TO BE APPLIED TO CEMENT BOARD AS RECOMMENDED BY MANUFACTURER

CLEAN SUCH THAT NO HAZE TO REMAIN.

6. STAGGER TILE PATTERN AT 1/3 TILE LENGTH.

LAYOUT ON PLAN FOR REFERENCE ONLY

7. PLAN LAYOUT TO MINIMIZE TILES LESS THAN 1"

8. LIPPAGE TOLERANCE IS 1/32". KEEP TO MINIMUM.

4. CAULK ALL INSIDE CORNERS AT TILE

5. MAINTAIN EXIST. CONTROL JTS. IN TILE.


ALL GROUT TO BE EPOXY. CLEAN RESIDUE IN SMALL AREAS

2. GROUT JOINTS TO BE 1/8".

This original sheet is 22" x 34"; other dimensions indicate it has been altered.

All information on this sheet is the property of W. S. Architects, PA and may not be duplicated in whole or in part without written

authorization from W. S. Architects, PA. 2020 ©

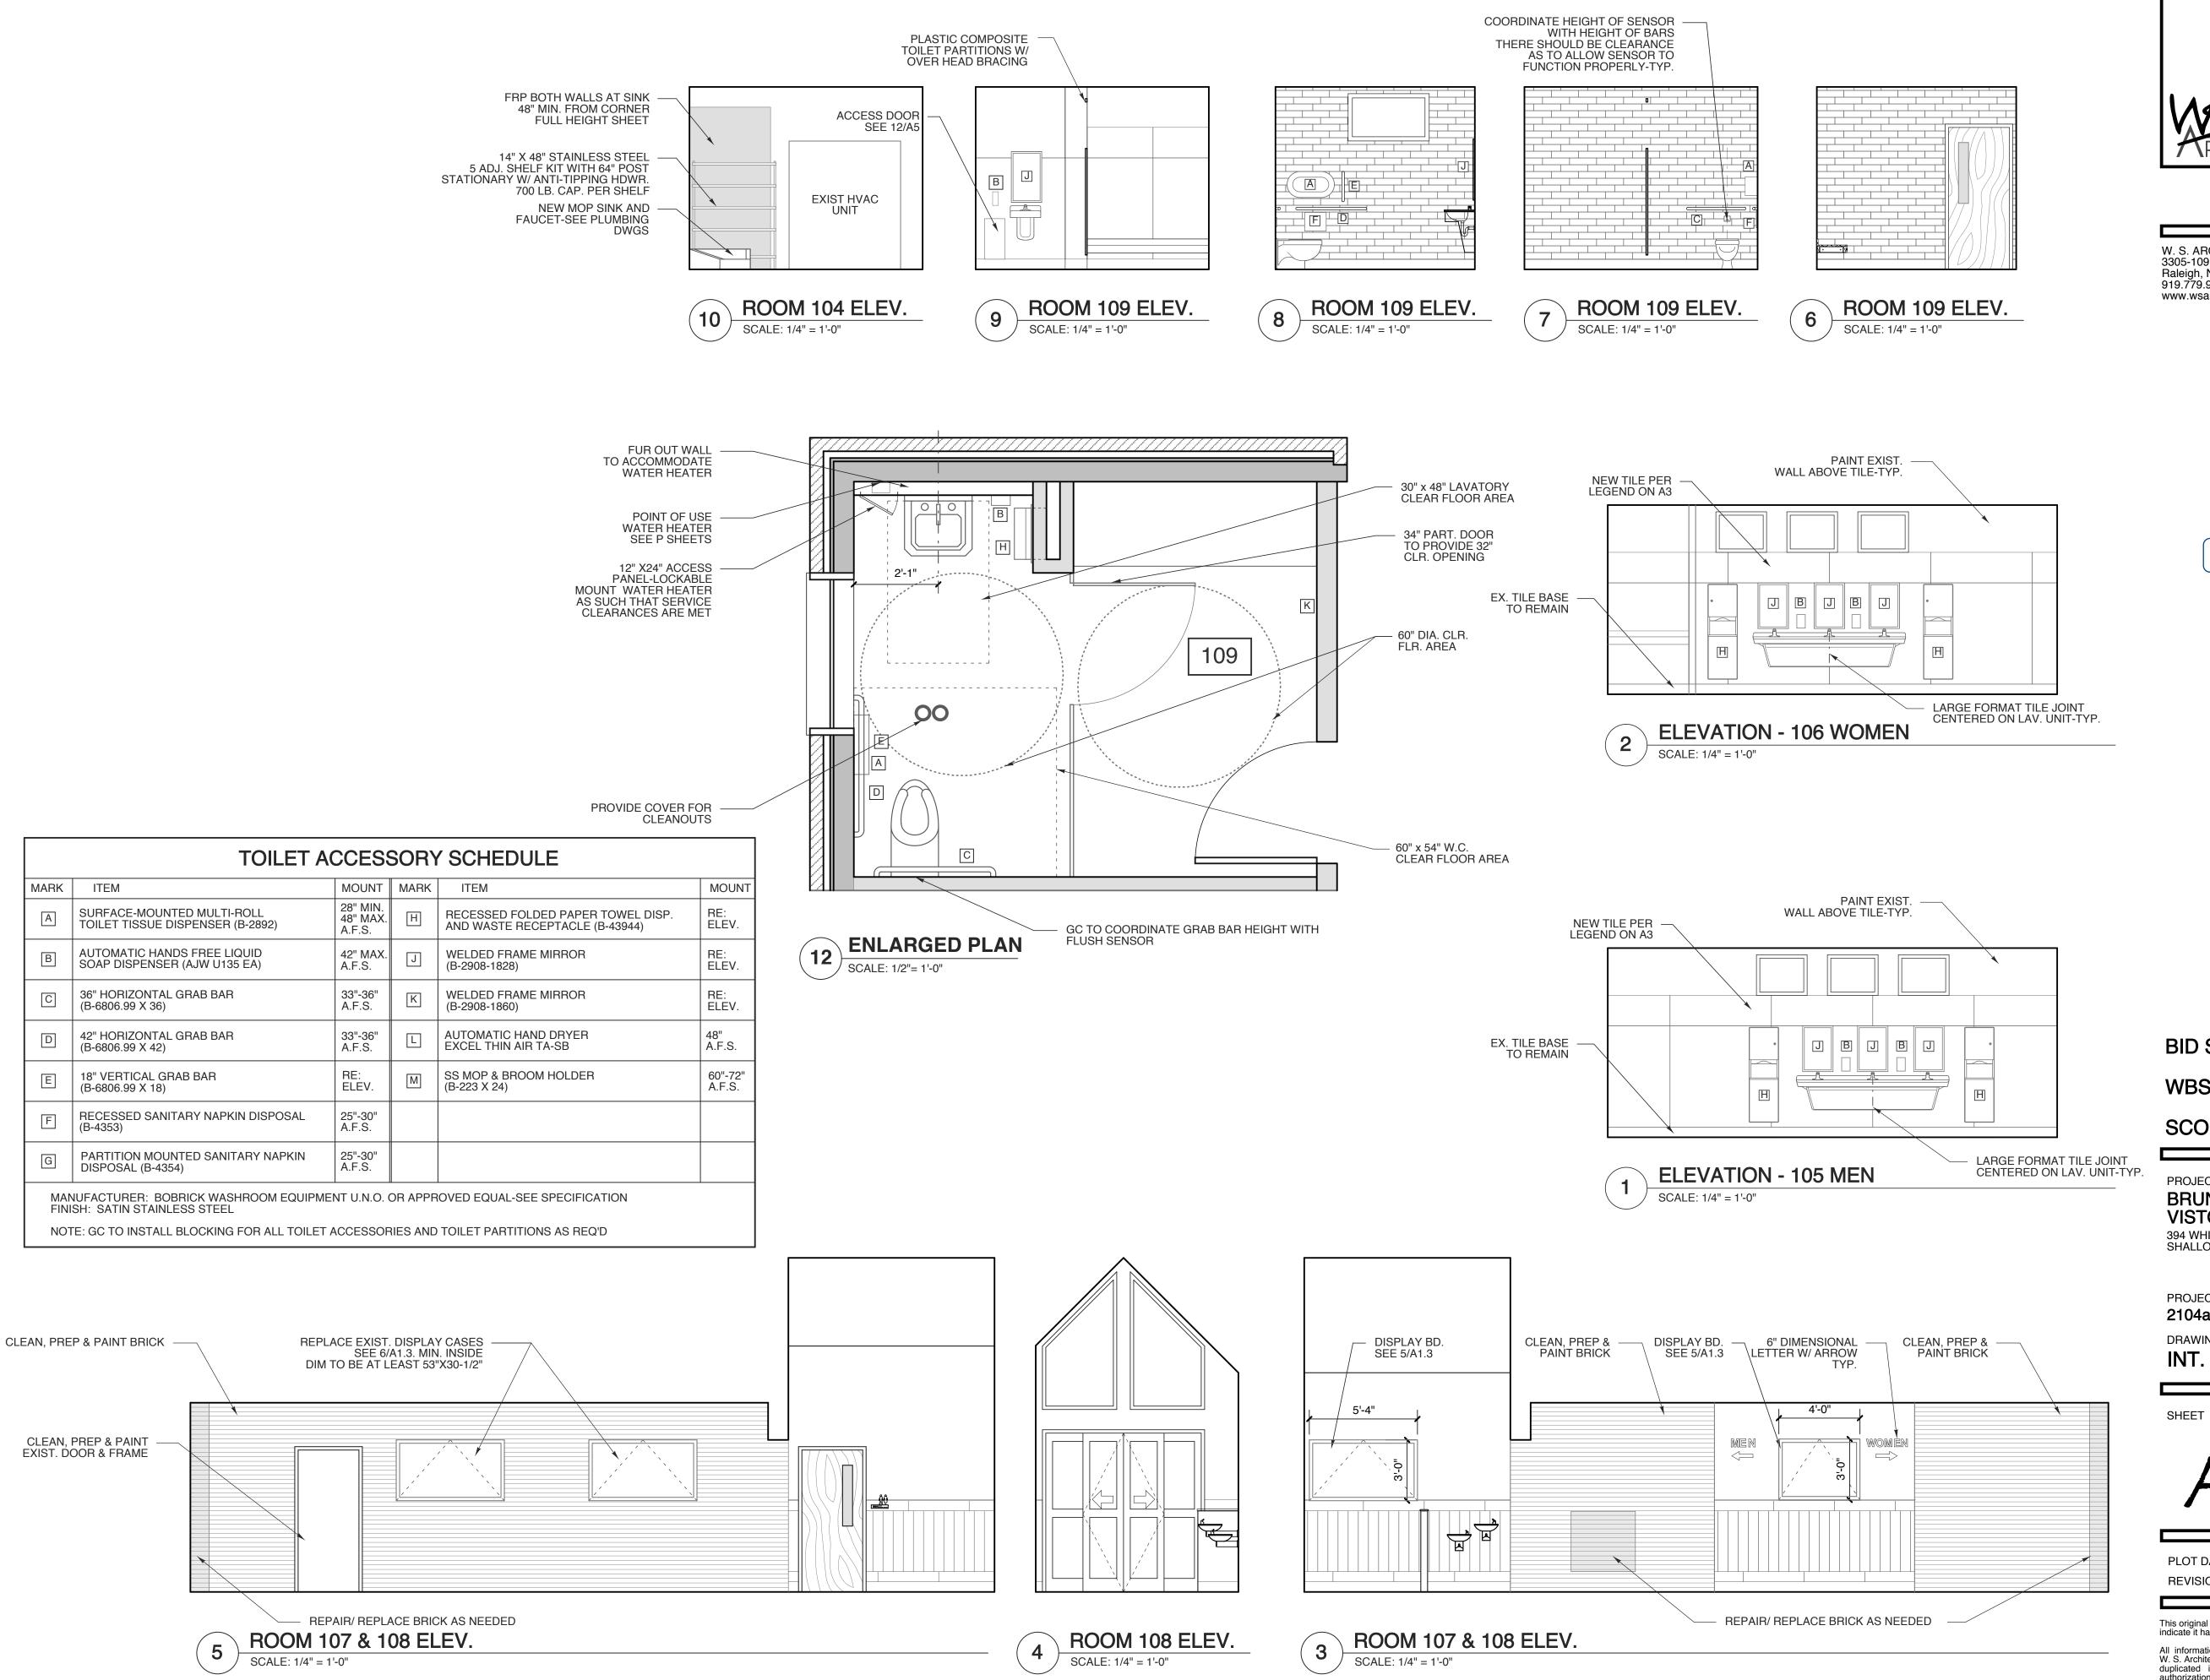

WEEKS SUMMER

W. S. ARCHITECTS, PA 3305-109 Durham Drive Raleigh, North Carolina 27603 919.779.9797 www.wsarchitectspa.com

Hinger S. Summer

BID SET 4.28.22

WBS: 15RE.13.3

SCO ID# 21-24079-01A

PROJECT TITLE **BRUNSWICK CTY** VISTOR'S CENTER 394 WHITEVILLE ROAD NW SHALLOTE, NORTH CAROLINA

PROJECT NO. 2104a

DRAWING TITLE **INT. ELEVATIONS**

OF

PLOT DATE REVISION

This original sheet is 22" x 34"; other dimensions indicate it has been altered.

6/16/2/323


00/00/00

All information on this sheet is the property of W. S. Architects, PA and may not be duplicated in whole or in part without written authorization from W. S. Architects, PA. 2020 ©



W. S. ARCHITECTS, PA 3305-109 Durham Drive Raleigh, North Carolina 27603 919.7797 www.wsarchitectspa.com



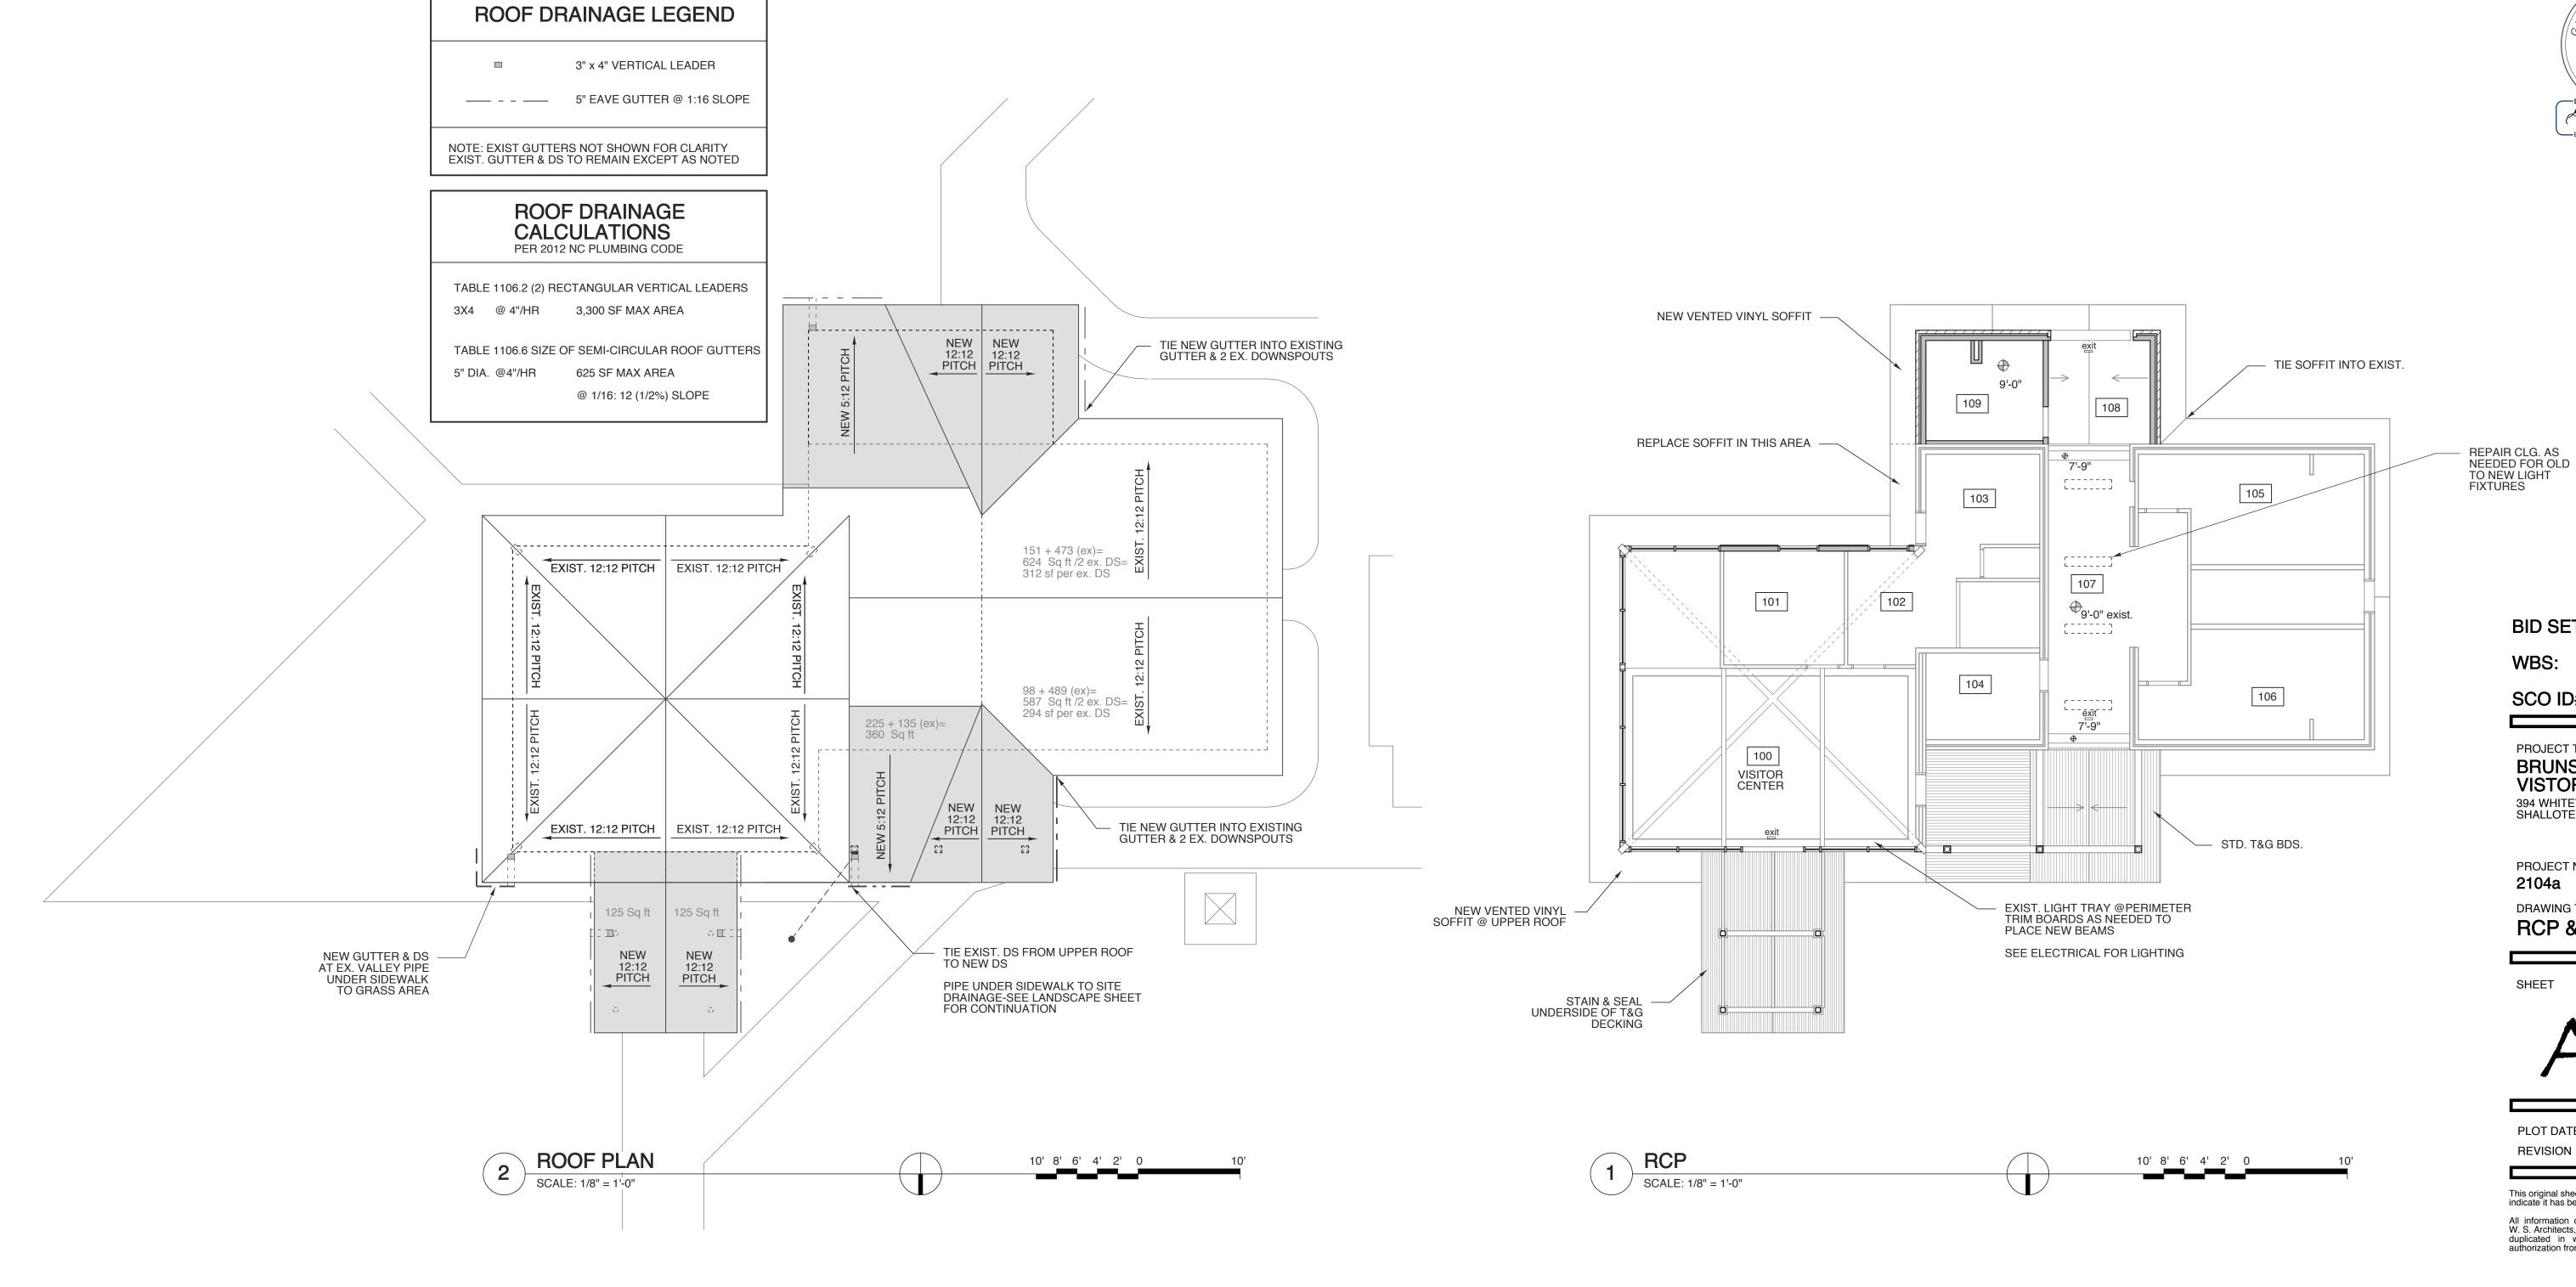

BID SET

15RE.13.3 SCO ID# 21-24079-01A

5.1.23

PROJECT TITLE **BRUNSWICK CTY** VISTOR'S CENTER 394 WHITEVILLE ROAD NW SHALLOTE, NORTH CAROLINA

PROJECT NO. 2104a

DRAWING TITLE **RCP & ROOF PLAN**

SHEET


PLOT DATE REVISION

This original sheet is 22" x 34"; other dimensions indicate it has been altered.


6/16/2/323

00/00/00

All information on this sheet is the property of W. S. Architects, PA and may not be duplicated in whole or in part without written authorization from W. S. Architects, PA. 2020 ©

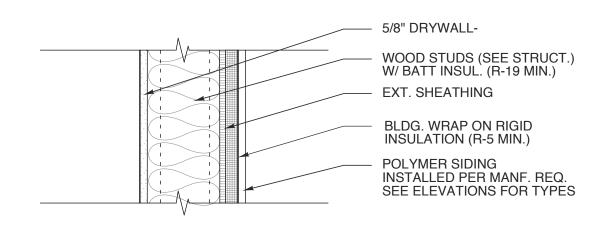


TYPICAL SIDING WALL SCALE: 1 1/2" = 1'-0"

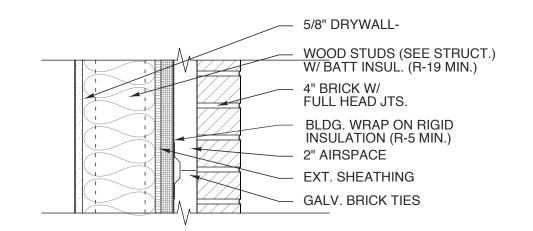


TYPICAL BRICK VENEER WALL SCALE: 1 1/2" = 1'-0"


TYP. NOTE: NEW BRICK TO MATCH EXIST. AS CLOSE AS POSSIBLE. TRIANGLE 'OLD SOUTH' OR APPROVED BEST MATCH. COLORED MORTAR TO MATCH AS WELL. CONTRACTOR TO PROVIDE SAMPLE PANEL FOR APPROVAL.

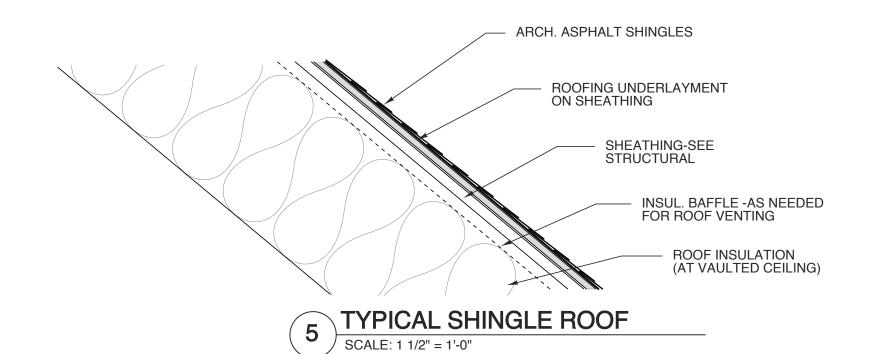


WEEKS SUMMER

W. S. ARCHITECTS, PA 3305-109 Durham Drive Raleigh, North Carolina 27603 919.779.9797 www.wsarchitectspa.com

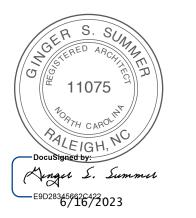

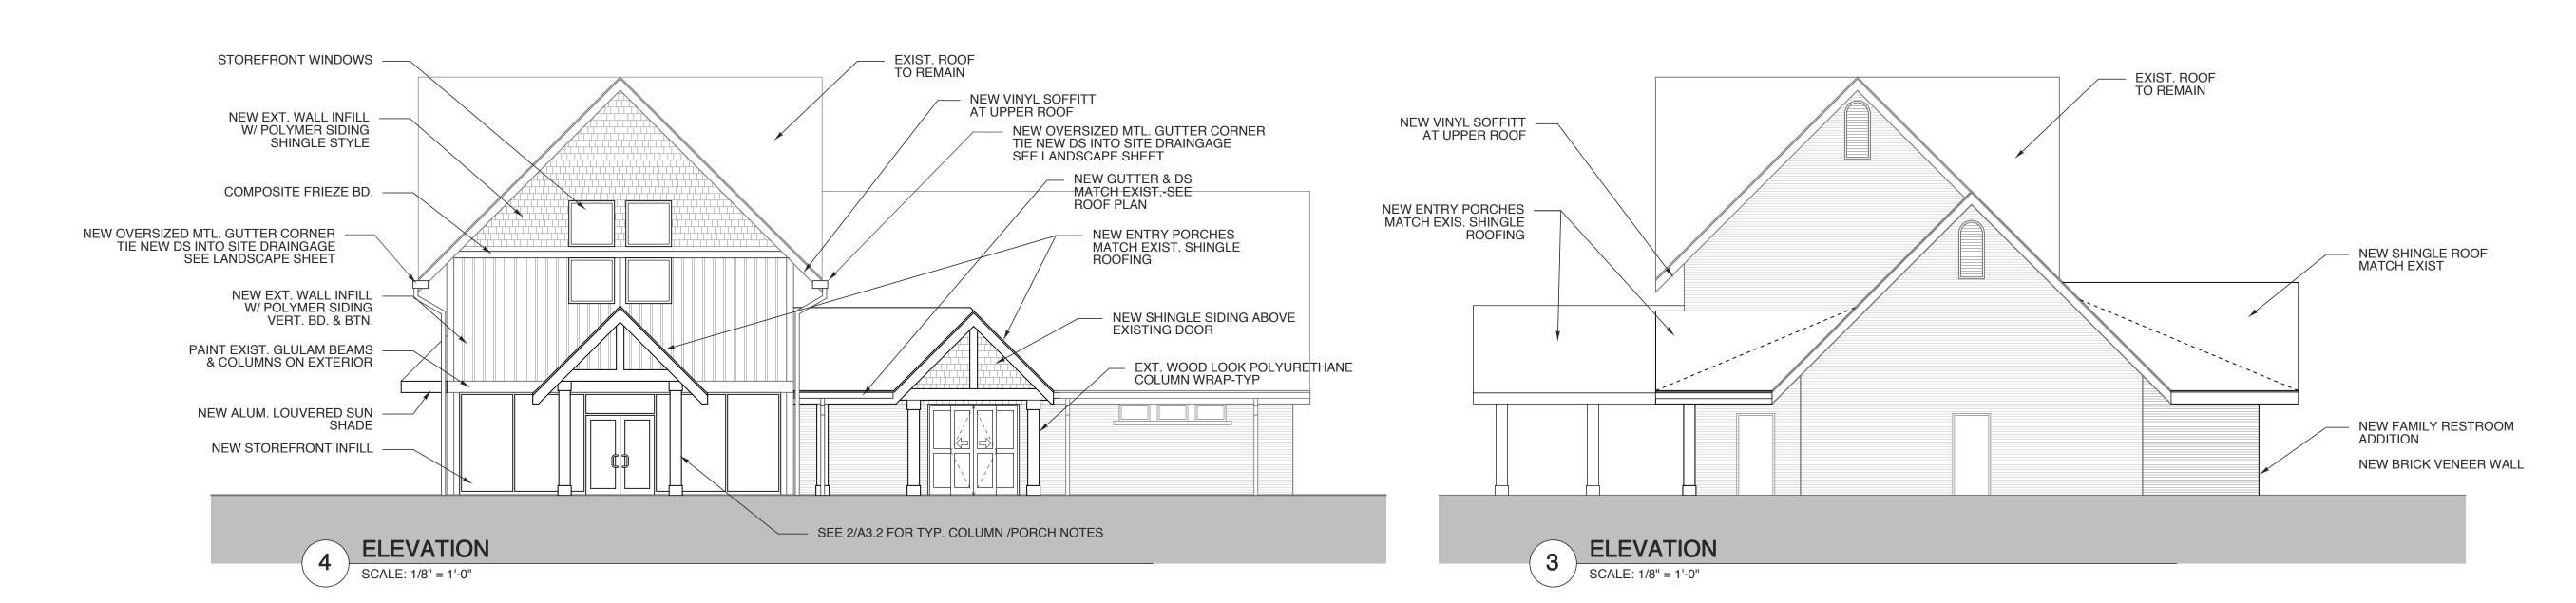

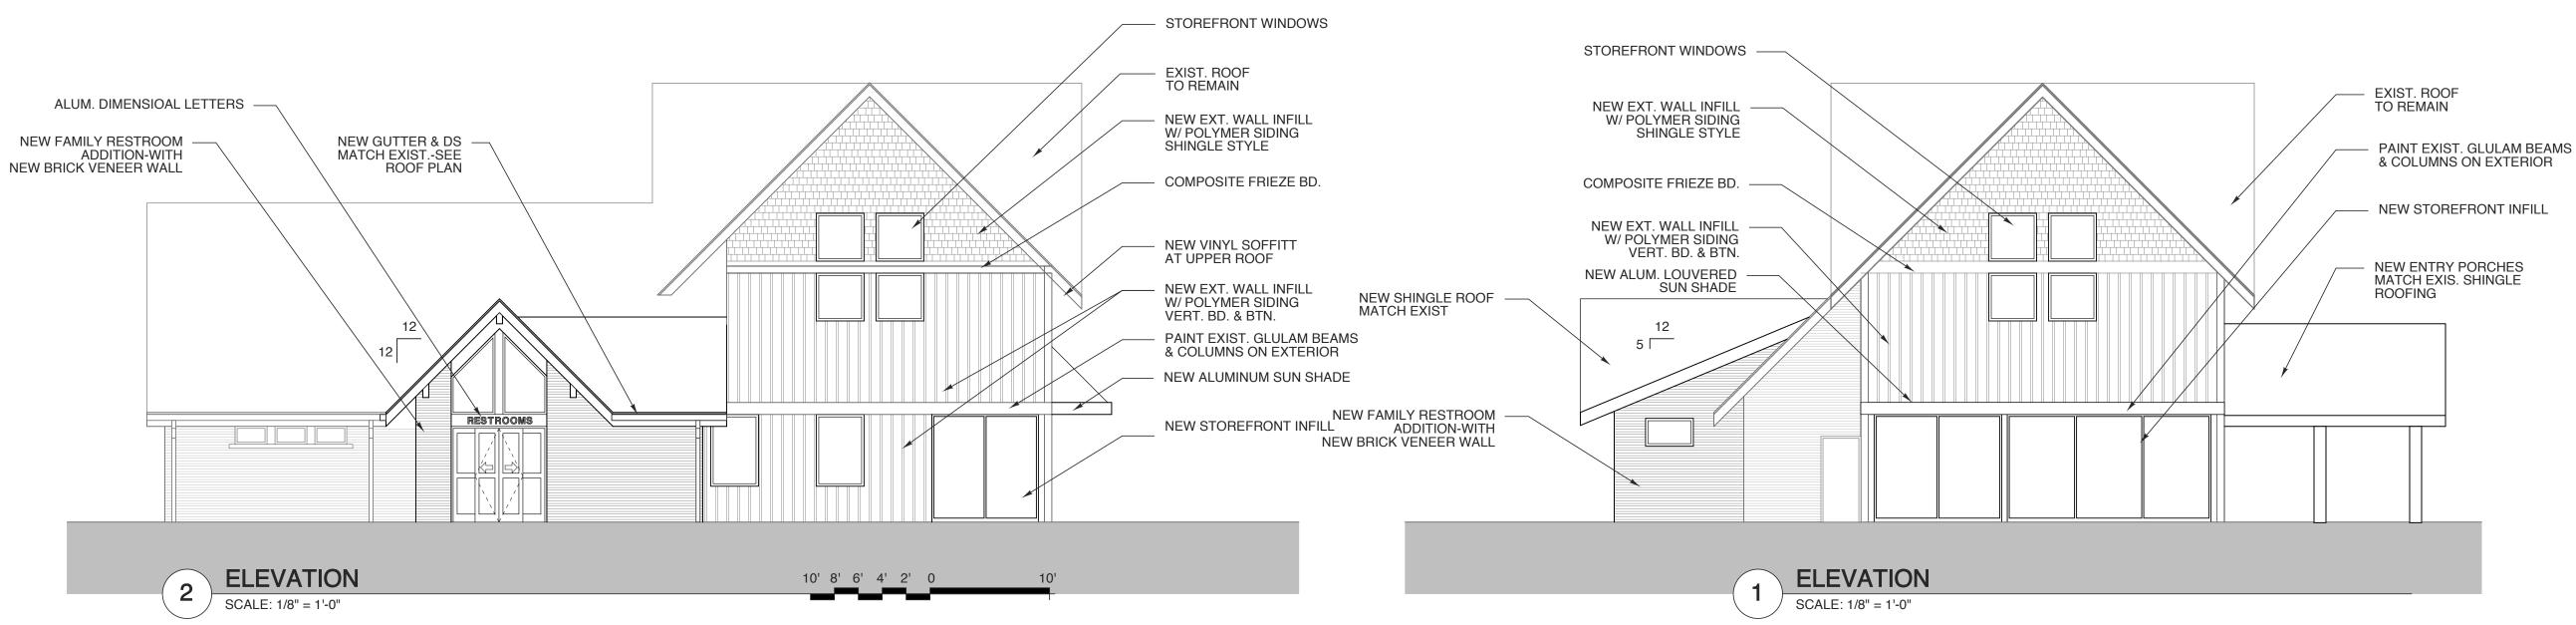

BID SET 5.1.23

15RE.13.3

SCO ID# 21-24079-01A

PROJECT TITLE **BRUNSWICK CTY** VISTOR'S CENTER 394 WHITEVILLE ROAD NW SHALLOTE, NORTH CAROLINA


PROJECT NO. 2104a

DRAWING TITLE **ELEVATIONS**


PLOT DATE 6/16/23 REVISION 00/00/14

This original sheet is 24" x 36"; other dimensions indicate it has been altered.

All information on this sheet is the property of W. S. Architects, PA and may not be duplicated in whole or in part without written authorization from W. S. Architects, PA. 2020 ©

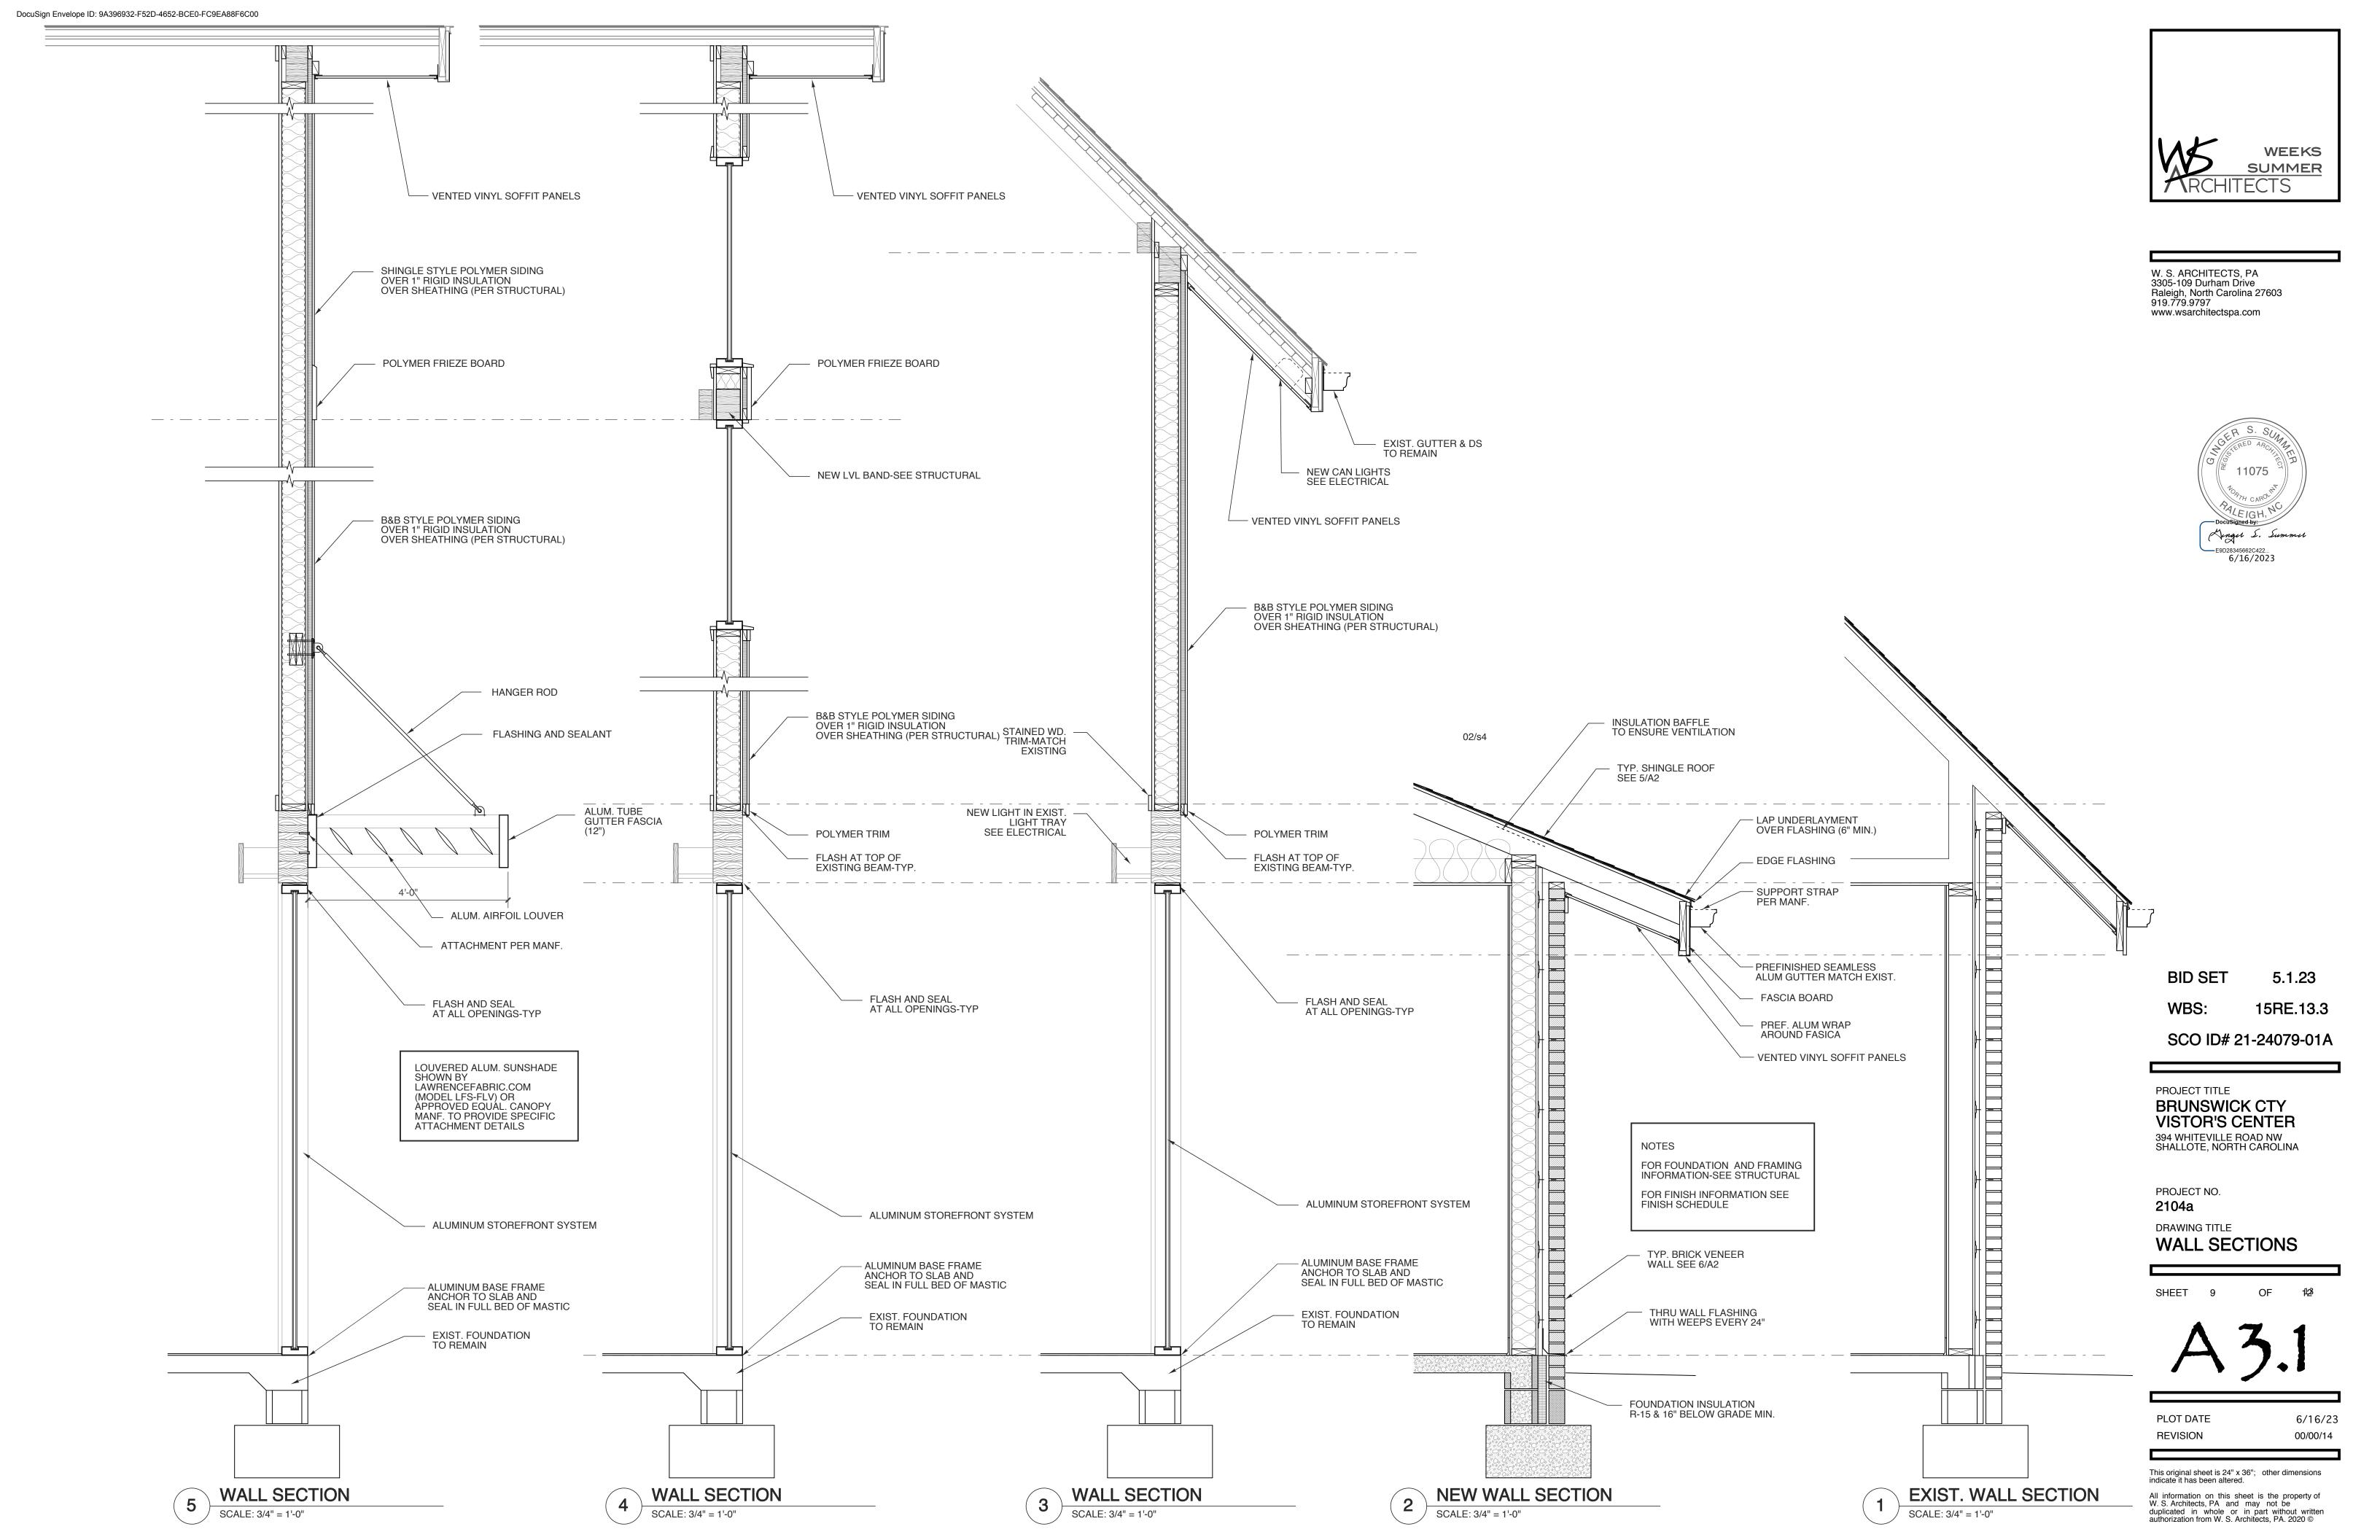



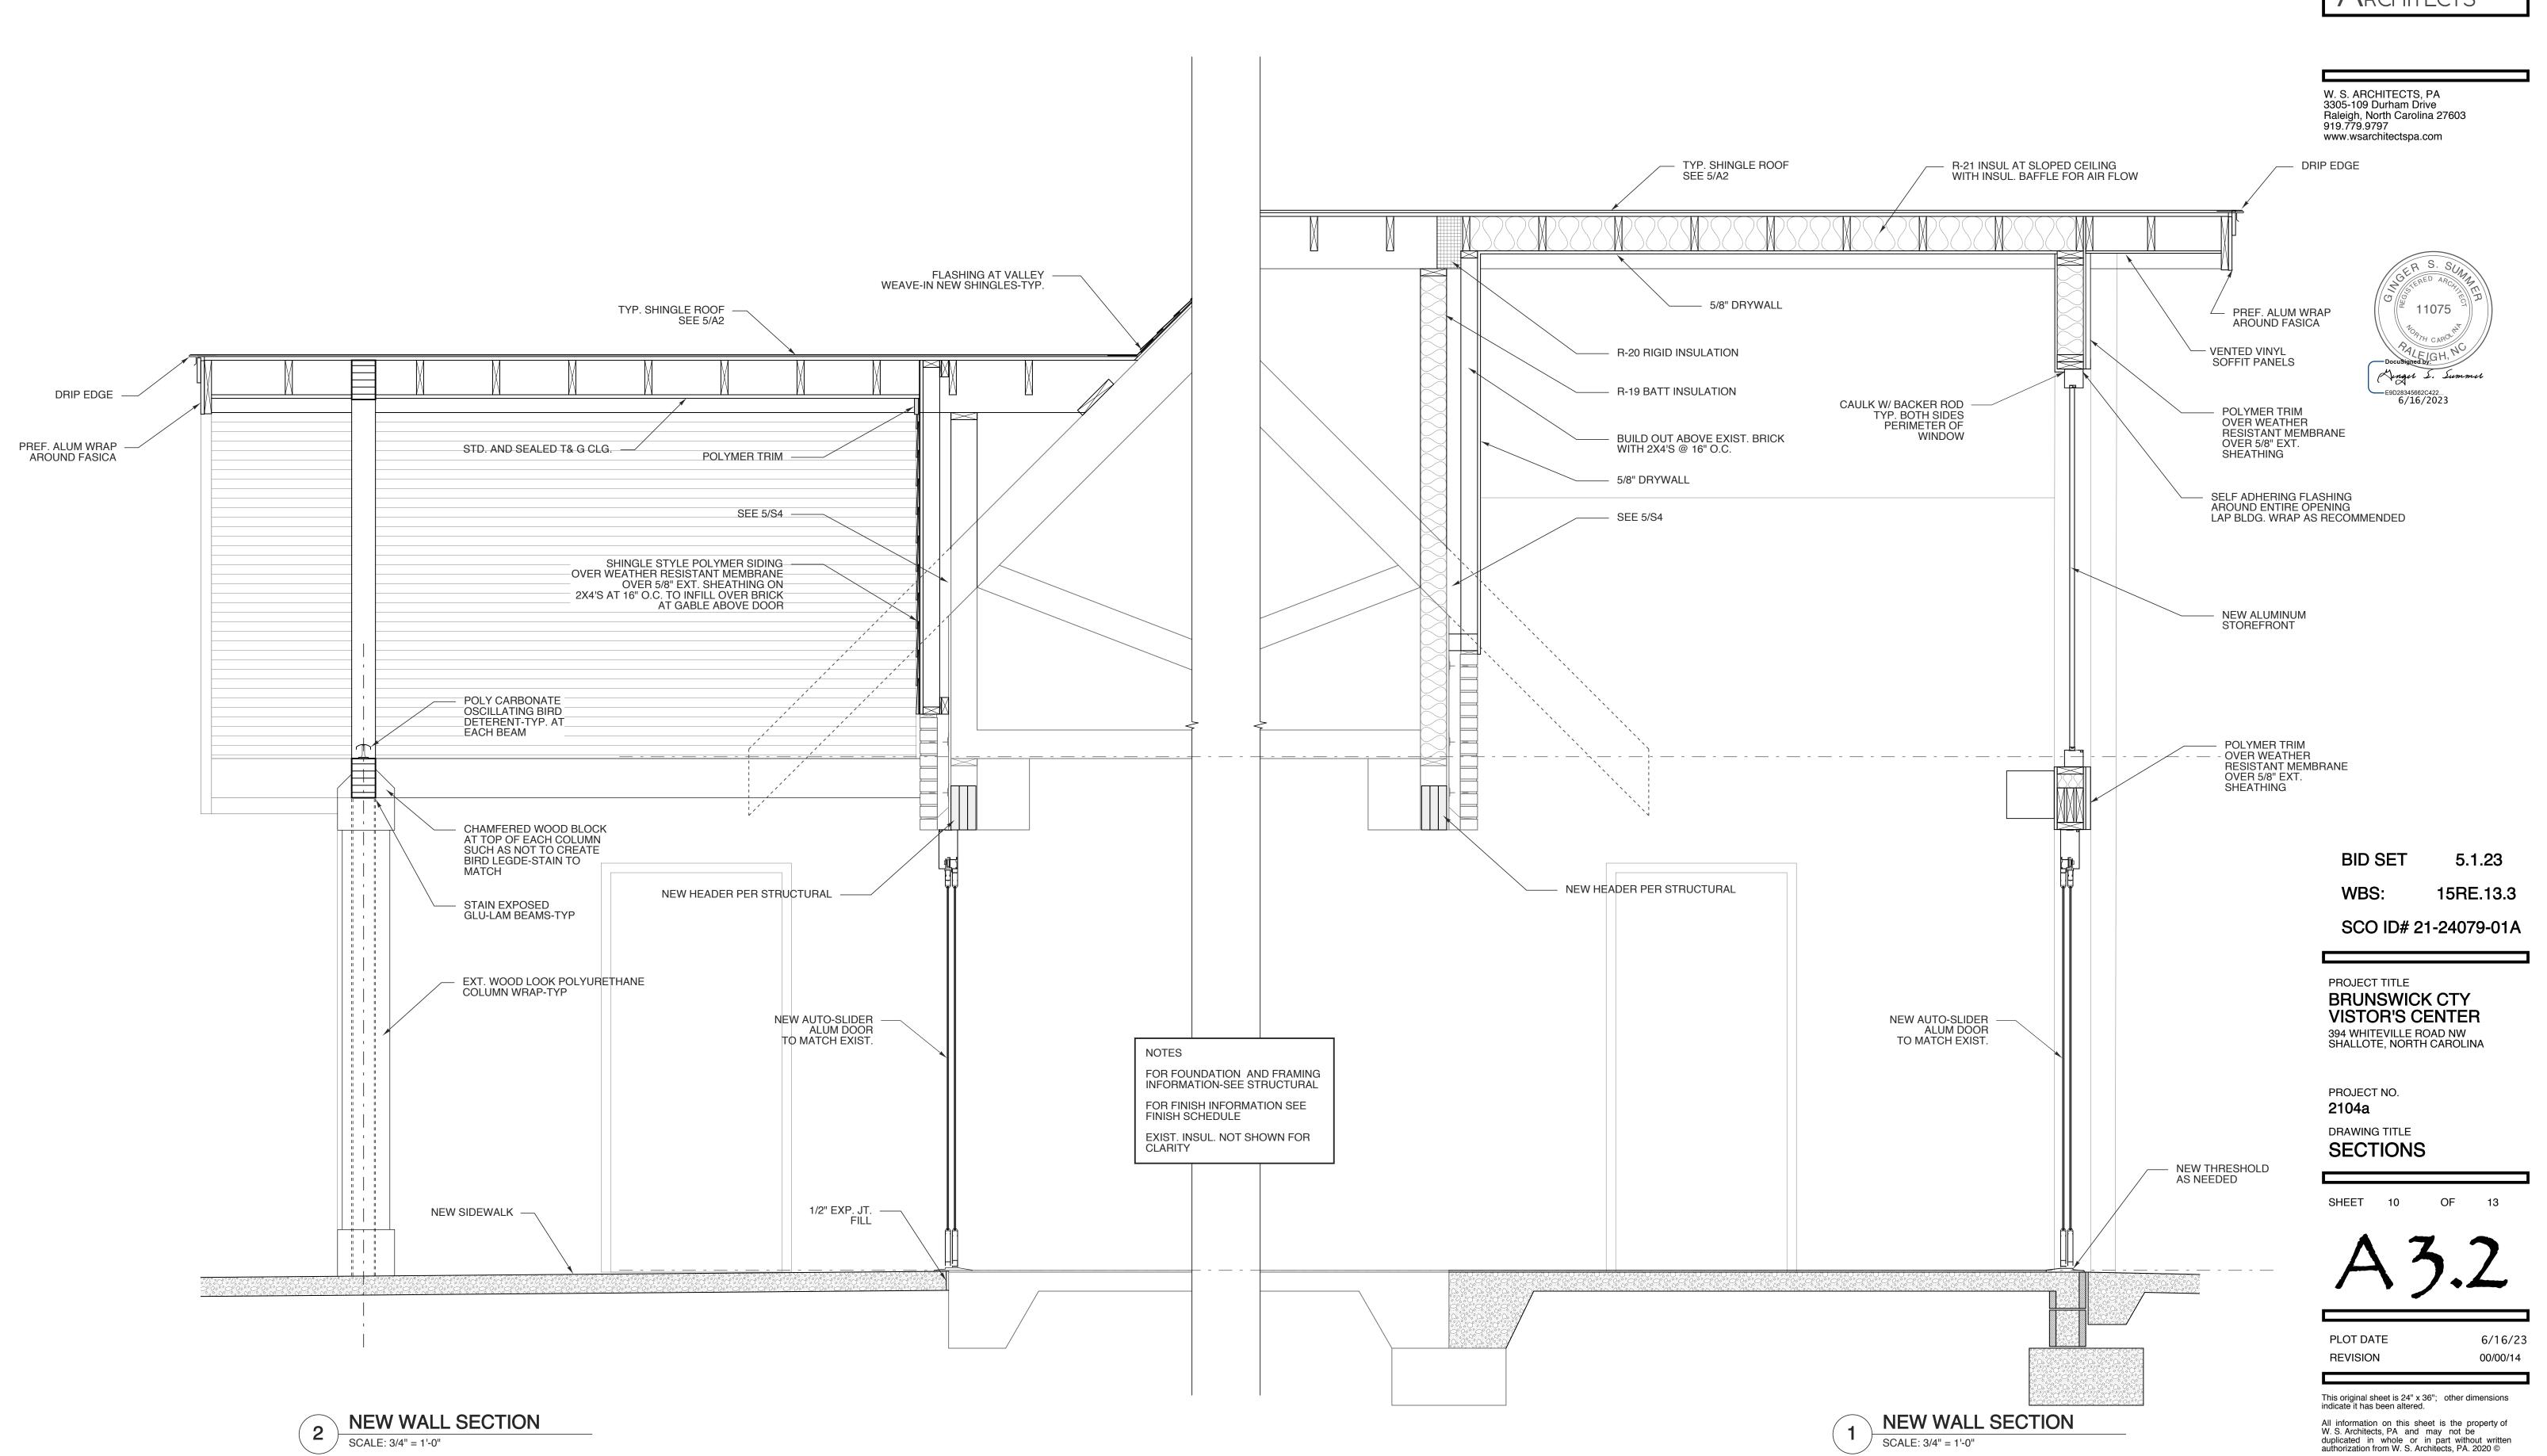

TYP. BRICK VENEER

THRU-WALL

FLASHING

WEEP HOLES

ST'L LINTEL-SEE STRUCT. DWGS.

TYP. BRICK VENEER

FLASHING

WINDOW SILL

BRICK ROWLOCK SILL (SLOPE MORTAR JOINTS) TYPICAL

THRU-WALL FLASHING

GROUT SOLID BEHIND

TYP. BRICK VENEER

A ALUMINUM STOREFRONT

BOT. OF BEAM EL. = 9'-0"


W/ WEEP HOLES

SILL-TYP.

SCALE: 1 1/2"= 1'-0"

FLASHING

@ 24" O.C.

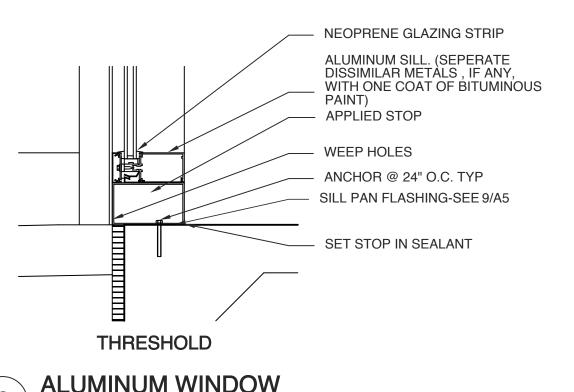

WOOD FRAMING-REFER TO STRUCTURAL DWGS-TYP.

CAULK W/ BACKER ROD TYP. BOTH SIDES

ALUM STOREFRONT SYS.

SELF ADHERING FLASHING AROUND ENTIRE OPENING

WOOD FRAMING-REFER TO

RETURN SPEC'ED FINISH BACK

STRUCTURAL DWGS-TYP.

CAULK W/ BACKER ROD

ALUM STOREFRONT SYS.

ALUM STOREFRONT SYS.

SILL PAN FLASHING-SEE 9/A5

ALUMINUM STOREFRONT

CAULK W/ BACKER ROD

TYP. BOTH SIDES

SOLID SURFACE SILL

SECURE TO BLOCKING (OVERLAP BRICK) TYP.

WITH ANCHOR STRAPS TO

TYP. BOTH SIDES

LAP BLDG. WRAP AS RECOMMENDED

HEAD

JAMB

THRESHOLD

SCALE: 1 1/2"= 1'-0"

JT. AT TOP OF WINDOW TO BE ABLE TO ACCOMODATE DEFLECTION OF BEAM

INT. SOLID WOOD DOOR

RETURN SPEC'ED FINISH BACK

	目 / THRESHOLD	
6	ALUMINUM WINDOW SCALE: 1 1/2"= 1'-0"	

HEAD

JAMB

SILL

ALUMINUM WINDOWS @ brick

0/

WINDOW SCHEDULE						
MARK	W SIZE H	MATERIAL	GLASS	REMARKS		
(A)	8'-11" x 9'-0"	ALUM STOREFRONT	1" INSUL.			
⟨B⟩	10'-8" x 9'-0"	ALUM STOREFRONT	1" INSUL.			
(C)	17'-0" x 9'-0"	ALUM STOREFRONT	1" INSUL.			
D	10'-11" x 9'-0"	ALUM STOREFRONT	1" INSUL.			
(E)	10'-11" x 9'-0"	ALUM STOREFRONT	1" INSUL.			
F	4'-0" x 6'-0"	ALUM STOREFRONT	1" INSUL.			
G	4'-0" x 2'-4"	ALUM STOREFRONT	1" INSUL.	OBSCURE GLASS		
$\langle H \rangle$	4'-0" x 4'-0"	ALUM STOREFRONT	1" INSUL.			
J	3'-8" x 6'-8"	ALUM STOREFRONT	1" INSUL.	45 DEG. ANGLE TOP		
K	3'-8" x 6'-8"	ALUM STOREFRONT	1" INSUL.	45 DEG. ANGLE TOP		

NOTES:

STOREFRONT BASIS OF DESIGN KAWNEER TRIFAB 601T. FINISH TO MATCH EXISTING.

HEAD

SEE ENERGY REPORT ON COVER SHEET FOR REQUIRED THERMAL VALUES.

ALL FRAME DIMENSIONS TO BE FIELD VERIFIED.

- 5/8" DRYWALL (BOTH SIDES)

CAULK BOTH SIDES

- DOOR

- HOLLOW METAL FRAME

- HOLLOW METAL FRAME

– HOLLOW METAL FRAME

THRESHOLD (IF REQUIRED)

FINISH FLOOR MATERIAL


D ALUMINUM STOREFRONT

- WALL STUDS

- 5/8" DRYWALL

DOOR

ALL WINDOWS TO MEET NCSBC SECTION 1609.1.2

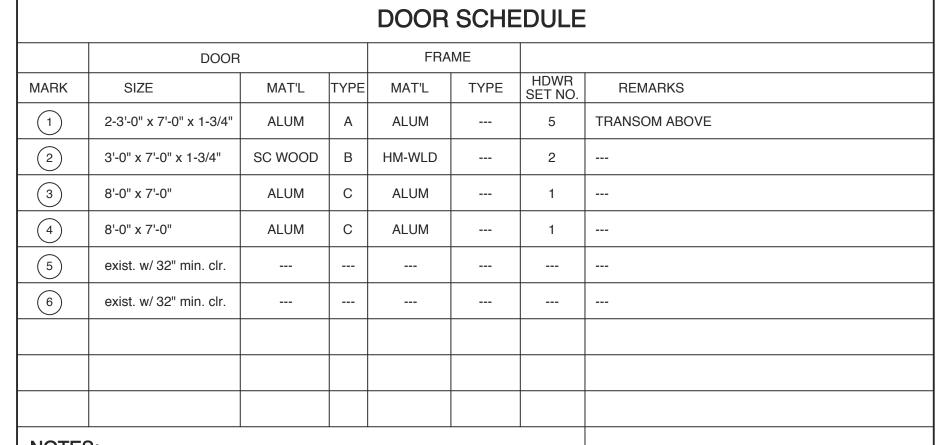

WEEKS **SUMMER**

W. S. ARCHITECTS, PA 3305-109 Durham Drive Raleigh, North Carolina 27603 919.779.9797 www.wsarchitectspa.com



NOTES:

SHIM AS NEEDED

- CAULK BOTH SIDES

-ALUMINUM FRAME

- TRANSOM ABOVE

-ALUMINUM MULLION

-WEATHERSTRIPPING

-ALUMINUM / GLASS DOOR

- ALUMINUM / GLASS DOOR

E ALUM. STOREFRONT


- COORDINATE KEYING OF HARDWARE WITH OWNER

- DOOR HANDLES TO BE LEVER HANDLE

- ALL DOORS TO MEET NCSBC SECTION 1609.1.2

- PUSH/PULL HARWARE & KICK PLATE FINISHES TO MATCH HANDLESETS -STOREFRONT BASIS OF DESIGN KAWNEER TRIFAB 601T. FINISH TO MATCH EXISTING.

-SEE ENERGY REPORT ON COVER SHEET FOR REQUIRED THERMAL VALUES.

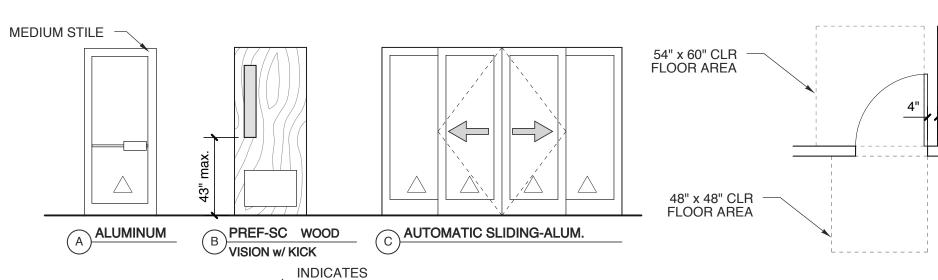


HARDWARE SETS


PASSAGE SET

SEE SPEC FOR MORE INFORMATION

AUTOMATIC SLIDING W/EMERGENCY BREAK AWAY OPERATION

STOREROOM FUNCTION LOCKSET ADA CUP PULL (COL-405-15CC OR EQUAL) PUSH / PULL HARDWARE WITH CLOSER

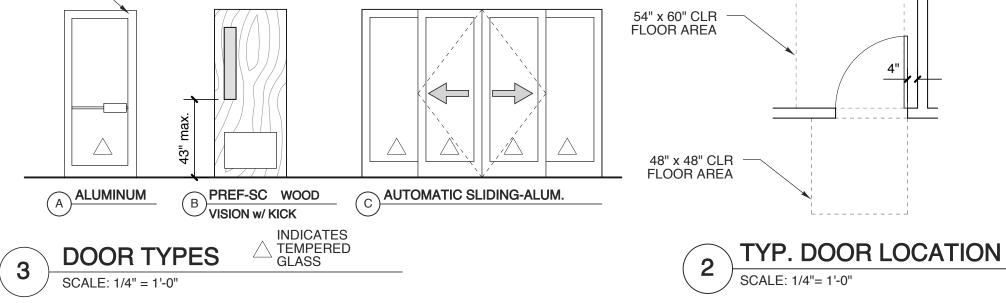

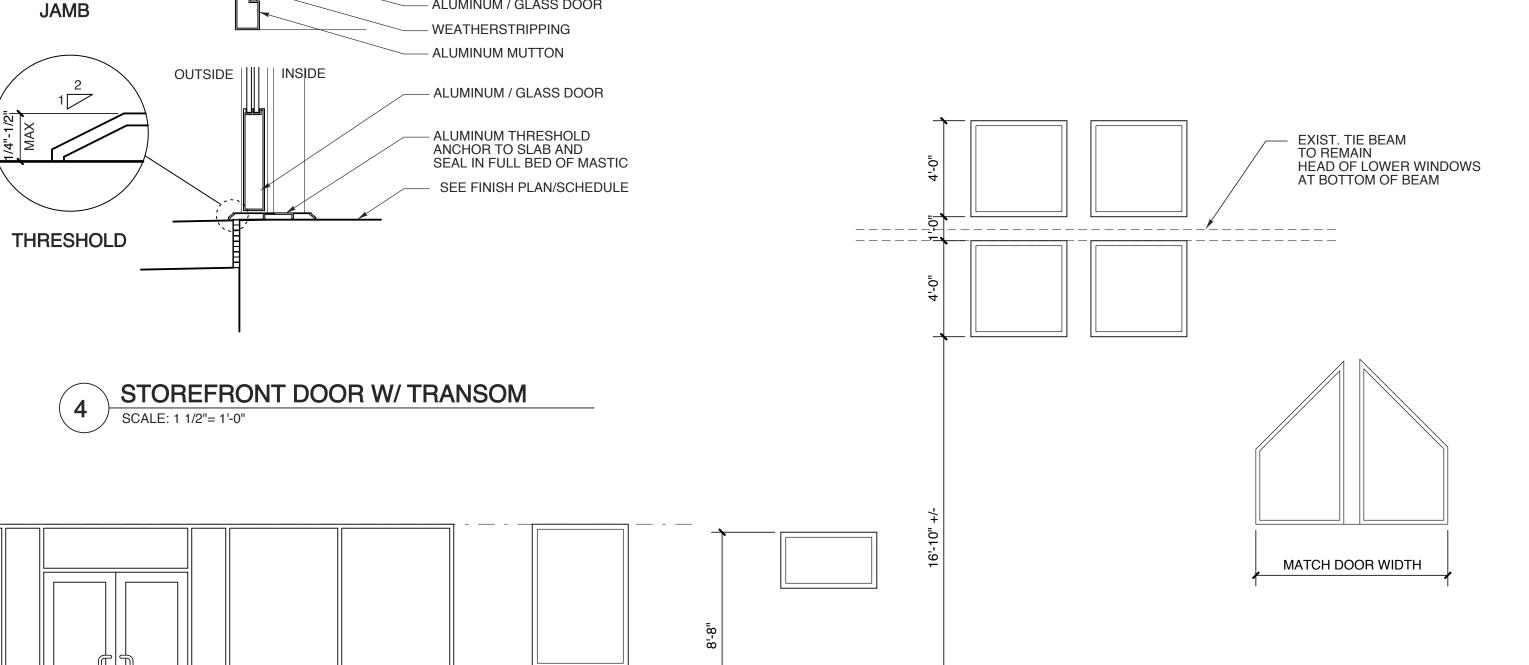

ALUMINUM STOREFRONT

ALUMINUM STOREFRONT

5.1.23 **BID SET**

15RE.13.3

SCO ID# 21-24079-01A

PROJECT TITLE **BRUNSWICK CTY VISTOR'S CENTER** 394 WHITEVILLE ROAD NW SHALLOTE, NORTH CAROLINA

PROJECT NO. 2104a DRAWING TITLE **DOOR & WINDOW** SCHED/DETAILS

OF SHEET



PLOT DATE REVISION

JK ALUMINUM STOREFRONT

00/00/00

6/16/23

This original sheet is 24" x 36"; other dimensions indicate it has been altered. All information on this sheet is the property of W. S. Architects, PA and may not be duplicated in whole or in part without written authorization from W. S. Architects, PA. 2020 ©



ALUMINUM STOREFRONT

